MISC. GENERAL NOTES

I. THIS PROJECT IS THE ADDITION AND RENOVATION OF A 2-FAMILY, ONE AND A HALF STORY STRUCTURE, ZONED AS R-2. THE STRUCTURE IS IN THE HISTORIC DISTRICT. 2. THE EXISTING HEIGHT OF THE STRUCTURE AS DEFINED BY THE BUILDING CODE of NEW YORK STATE 2020 IS 19'-11". THE PROPOSED HEIGHT IS 26'-1".

3. THE TYPE OF CONSTRUCTION IS TYPE V (B). 4. ALL WORK SHALL CONFORM TO THE REQUIREMENTS OF THE 2020 BUILDING CODE of NEW YORK STATE, 2020 EXISTING BUILDING CODE of NEW YORK STATE, AND THE AF & PA WOOD FRAME CONSTRUCTION MANUAL 2015 HIGH WIND EDITION.

5. DESIGN LOAD CALCULATION ARE BASED ON: LIVE LOAD: AS PER TABLE R30 | .4, BUILDING CODE of NEW YORK STATE 2020. DEAD LOAD: CALCULATED AS PER R301.3 AS PER BCNYS 2020. SNOW LOAD: 20 PSI GROUND SNOW LOAD (AS PER FIG. R301.2(5) BCNYS 2020. WIND EXPOSURE CATEGORY "C", FOR 130 MPH 3 SECOND GUST.

LIVE DEAD DELECT LIMIT 40 LB. 12 L/360 2ND.FL. (SLEEP AREA) 30 LB. 12 L/360 ATTIC (NON STORAGE) 20 LB. 10 L/360 20 LB. 15 L/360

6. THE ARCHITECT ASSUMES NO RESPONSIBILITY FOR THE CONSTRUCTION MEANS, METHODS, TECHNIQUES, SEQUENCES, OR PROCEDURES, OR FOR SAFETY PRECAUTIONS AND PROGRAMS IN CONNECTION WITH THE WORK.

THERE ARE NO WARRANTIES, NOR ANY MERCHANTIBILITY OF FITNESS FOR A SPECIFIC USE EXPRESSED OR IMPLIED IN THE USE OF THESE PLANS. 7. CONTRACTOR TO VERIFY ALL DIMENSIONS BEFORE STARTING CONSTRUCTION. DO NOT SCALE DRAWINGS. FOLLOW DIMENSIONS ONLY.

8. CONTRACTOR(S) SHALL FURNISH AND INSTALL ALL MATERIAL AND EQUIPMENT SHOWN, LISTED, OR

DESCRIBED ON THESE DRAWINGS SUBJECT TO QUALIFICATIONS, CONDITIONS, OR EXCEPTIONS AS NOTED. CONTRACTOR SHALL FURNISH ALL LABOR, SCAFFOLDING, AND TOOLS NECESSARY TO 9. ALL MATERIAL SHALL BE INSTALLED IN STRICT CONFORMANCE WITH MANUFACTURES REQUIREMENTS

10. CONTRACTOR SHALL OBTAIN ALL REQUIRED INSPECTIONS, APPROVALS AND CERTIFICATE OF OCCUPANCY.

DEMOLITION

AS NECESSARY, AND REMOVE DEBRIS. 2. CONTRACTOR SHALL DO ALL PATCHING REQUIRED DUE TO REMOVAL OF EXISTING WORK AND OR INSTALLATION OF NEW YORK. 3. ALL NEW WORK SHALL MATCH AND MEET FLUSH TO EXISTING WORK AS CLOSELY AS POSSIBLE UNLESS 4. EXISTING STRUCTURE AND INTERIORS TO REMAIN SHALL BE PROTECTED AS NECESSARY DURING DEMOLITION AND CONSTRUCTION. 5. CONTRACTOR SHALL PROTECT EXISTING SERVICES TO REMAIN AND SHALL NOTIFY ALL UTILITIES AND

I. CONTRACTOR SHALL DEMOLISH WALLS, FLOOR, AND EXISTING ROOF AS INDICATED ON DRAWINGS AND

TELEPHONE SERVICES AND MAKE ARRANGEMENTS FOR HOOK-UP, REMOVAL, OR CAPPING OF EQUIPMENT AS NECESSARY.

I. ASSUMED SOIL BEARING CAPACITY, 1,500 lb./Sq.Ft. 2. CONCRETE TO BE PLAIN, REINFORCED, 3,000 psi. -28 DAY TEST.

3. ALL NEW FOOTINGS TO REST ON UNDISTURBED SOIL.

GENERAL CONSTRUCTION I. PROVIDE ALL LABOR, MATERIALS, TRANSPORTATION, EQUIPMENT AND SERVICES NECESSARY TO

COMPLETE ALL WOOD AND PLASTIC WORK REQUIRED BY THE DRAWINGS AS SPECIFIED HEREIN, OR REASONABLY IMPLIED AS NECESSARY TO COMPLETE THE WORK. 2. FASCIAS, SOFFITS AND EXTERIOR TRIM SHALL MATCH EXISTING. 3. INTERIOR TRIM SHALL MATCH EXISTING.

4. FRAMING ELEMENTS: A. ALL FRAMING LUMBER SHALL BE GRADE STAMPED DOUGLAS FIR-LARCH STRUCTURAL GRADE NO.2 B. ALL ENGINEERED LUMBER SHALL BE AS INDICATED ON DRAWINGS, AND SHALL BE INSTALLED, CUT AND DRILLED IN ACCORDANCE WITH MANUFACTURERS REQUIREMENTS AND SPECIFICATIONS.

C. ALL SHEATHING TO BE APA RATED, EXPOSURE 1, THICKNESS AS INDICATED.

D. ALL SUB FLOORING TO BE APA RATED STURD-1-FLOOR, EXPOSURE 1, 3/4" MIN. THICKNES. E. ALL HEADERS 6'-O" AND OVER SHALL BE SUPPORTED WITH DOUBLE UPRIGHTS, 9'-O" AND OVER WITH TRIPLE UPRIGHTS. ALL HEADERS SHALL BE A MIN. OF (2)2'x8" OR AS SHOWN ON DRAWING.
F. SOLID BLOCKING SHALL BE PROVIDED FOR ALL JOISTS AND FLOOR BEAMS AS PER BCNYS 2020 OR AS NOTED @ 8'-0" O.C. MIN.. PROVIDE 2" SPACE FOR AIR CIRCULATION IN ROOF.
G. PROVIDE DOUBLE FRAMING AROUND ALL OPENINGS (STAIRS, ETC.) OR AS NOTED ON DRAWINGS.

H. PROVIDE DOUBLE UP FRAMING UNDER ALL POSTS AND PARALLEL PARTITIONS OR AS NOTED ON I. ALL FLUSH WOOD CONNECTIONS SHALL BE FASTENED WITH RATED GALVANIZED METAL CONNECTORS BY "SIMPSON" OR APPROVED EQUAL.

J. NAILING SCHEDULE SHALL BE AS PER BUILDING CODE of NEW YORK STATE 2020 AS A MINIMUM.

ALL 2"X6" STUDG SHALL RECEIVE (5) 10d NAILS AT SILL AND PLATE, ALL EXTERIOR NAILS SHALL BE GALVANIZED. SEE ATTACHED NAILING SCHEDULE.

K. PLYWOOD SHEATHING TO BE NAILED 8d NAILS @ 4" O.C. EXTERIOR EDGES AND 6d NAILS @ 12" O.C. INTERMEDIATE. SEE ATTACHED NAILING SCHEDULE.

L. ALL INTERIOR AND EXTERIOR FINISHES TO BE SELECTED BY OWNER.

L. ALL INITERIOR AND EXTERIOR FINISHED TO DE SELECTED OF OWNER.

M. ALL ROOF RAFTERS SHALL BE ATTACHED TO THE PLATE AND STUD WITH GALVANIZED HURRICANE
TYPE CONNECTORS BY "SIMPSON" OR APPROVED EQUAL. FOR TIMBER PILE FOUNDATIONS, PROVIDE 5. ALL NEW WINDOWS TO BE THERMAL INSULATED LOW-E GLASS, WITH ARGON GAS, IMPACT RESISTANT AS

6. LOAD PATHS ARE INDICATED BY SECTION DRAWINGS. CONNECTIONS SHALL BE BUILT IN ACCORDANCE WITH ANSI /AF /\$ PA WCFM-1995.(SEE NAILING 8. FLASHING AT ALL WINDOW AND DOOR OPENINGS SHALL BE EPDM OR APPROVED RUBBERIZED

9. FLASHING AT ROOF CONNECTIONS, VALLEYS, CHIMNEYS AND CRICKETS SHALL BE ALUMINUM. 10. STEP FLASHING SHALL BE USED AT ALL INTERSECTIONS OF SLOPED AND VERTICAL SURFACES, EXCEPT STEP FLASHING AND COUNTER- AND CAP- FLASHING SHALL BE USED AT INTERSECTION OF ROOF AND CHIMNEY, AND ROOF AND WALLS.

11. INSULATION SHALL BE BATT INSULATION OF THICKNESS INDICATED ON THE DRAWINGS AND SHALL BE

2-1/2 lb. DENSITY FIBER-GLASS BATTS CONFORMING TO THE SPECIFICATIONS FOR PRE-FORMED FIBROUS GLASS INSULATION NAAMM STANDARD SL. 16-70. CLOSED-CELL SPRAY-IN FOAM INSULATION (R-6.5 PER INCH) BY ICYNENE OR APPROVED EQUAL SHALL BE PROVIDED AS INDICATED ON DRAWINGS. 12. NEW INTERIOR DOORS SHALL MATCH EXISTING. 13. NEW HARDWARE SHALL MATCH EXISTING 14. GYPSUM BOARD SHALL BE EASED EDGE TYPE, CONFORMING TO ASTM C36, AND SHALL BE

"SHEETROCK SW" BY U.S. GYPSUM CO. OR APPROVED EQUAL. GYPSUM WALLBOARD THICKNESS SHALL BE 1/2" 15. ALL NEW AND REPAIRED GYP. BOARD SHALL BE TAPED AND SPACKLED THREE (3) COATS. ALL EXTERIOR CORNERS SHALL HAVE METAL CORNER BEADS.

FINISHES I. NEW WOOD FLOORS TO BE SELECTED BY OWNER, SANDED AND POLYURETHANE,

3COATS.
2. EXISTING WOOD FLOORS SHALL BE SANDED AND REFINISHED.
3. CERAMIC TILE FLOOR SHALL BE SELECTED BY OWNER AND INSTALLED WITH THIN SET

4. EXTERIOR PAINT SHALL BE LATEX ACRYLIC BY BENJAMIN MOORE OR APPROVED EQUAL, APPLIED IN ACCORDANCE WITH MANUFACTURER'S SPECIFICATIONS AND RECOMMENDATIONS. COLOR TO BE SELECTED. 5. EXISTING INTERIOR WALLS AND CEILINGS IN ROOMS AFFECTED BY THE WORK SHALL BE CLEANED AND REPAINTED. NEW WALLS AND CEILINGS SHALL BE SEALED AND PAINTED. PAINTING SHALL BE TWO (2) COATS BENJAMIN MOORE AQUA PEARL LATEX PAINTED, COLOR TO BE SELECTED .

G. INTERIOR TRIM SHALL BE SANDED SMOOTH, PRIMED, AND FINISHED WITH TWO (2) COATS BENJAMIN MOORE LATEX ACRYLIC SEMI-GLOSS PAINT

I. PROVIDE ALL LABOR, MATERIALS, TRANSPORTATION, EQUIPMENT AND SERVICES NECESSARY TO PROVIDE A HVAC SYSTEM TO HEAT AND COOL THE LIVING SPACES AS REQUIRED BY THE DRAWINGS AND SPECIFICATIONS AND THE 2020 MECHANICAL CODE of NEW YORK STATE, OR REASONABLY IMPLIED AS NECESSARY TO COMPLETE

2. EXISTING BOILER TO REMAIN. 2. EXISTING BOILER TO REMAIN.
3. EXISTING AIR HANDLERS AND CONDITIONERS TO REMAIN.
4. PROVIDE AIR-HANDLERS, DUCTWORK, AND CONTROLS AS NECESSARY TO COMPLETE THE WORK FOR AIR CONDITIONING IN ALL ZONES.
5. PROVIDE HOT WATER RADIANT HEAT TUBING AS NECESSARY FOR HEATING IN ALL ZONES.

PLUMBING

I. PROVIDE ALL LABOR, MATERIALS, TRANSPORTATION, EQUIPMENT, AND SERVICES NECESSARY TO COMPLETE ALL NEW PLUMBING WORK REQUIRED BY THE DRAWINGS AND SPECIFICATIONS AND THE 2020 PLUMBING CODE of NEW YORK STATE, OR REASONABLY IMPLIED AS NECESSARY TO COMPLETE THE WORK. 2. CONFORM TO THE NEW YORK STATE ENVIRONMENTAL CONSERVATION LAW WITH REGARDS TO WATER SAVING AND CONSERVATION. ALL FIXTURES SHALL BE ON THE APPROVED "LIST OF CERTIFIED WATER SAVING PLUMBING FIXTURES" AS PUBLISHED BY THE NEW YORK STATE DEPARTMENT OF ENVIRONMENTAL CONSERVATION. 3. ALL WORK ON THE PLUMBING SYSTEM SHALL BE PERFORMED BY OR UNDER THE SUPERVISION OF A PROPERLY LICENSED MASTER PLUMBER. UPON COMPLETION, THE PLUMBER SHALL PROVIDE A SOLDER CERTIFICATE AS REQUIRED BY THE TOWN OF 4. THE CONTRACTOR SHALL OBTAIN, SUBMIT, AND PAY FOR ALL PERMITS,

CERTIFICATIONS, LICENSES AND INSPECTIONS ASS REQUIRED BY LOCAL, STATE, AND FEDERAL AUTHORITIES, AND ANY OTHER APPLICABLE JURISDICTION. ELECTRICAL

I. FURNISH ALL LABOR, MATERIALS, EQUIPMENT, PLANT, TOOLS, AND SERVICES NECESSARY AND REQUIRED FOR PROPER AND COMPLETE INSTALLATION OF ALL NEW ELECTRICAL SYSTEMS AND RELATED WORK INCLUDING, BUT NOT LIMITED TO: CONNECTIONS TO PREVIOUSLY INSTALLED ELECTRICAL SYSTEMS, WIRING, LIGHTING SERVICES, FEEDERS, DISTRIBUTION AND PROTECTION EQUIPMENT, CONNECTIONS TO APPLIANCES, GROUNDING, AND ALL INCLUDING ALL CONNECTIONS AND DEVICES WITHIN THE SCOPE OF THE WORK AS SHOWN ON THE APPLICABLE DRAWINGS AND AND SPCIFICATIONS AND AS NORMALLY SPECIFIED IN THIS TYPE OF PROJECT AND INCLUDING CONNECTIONS TO PREVIOUSLY INSTALLED TRANSFORMERS AND ELECTRICAL DISTRIBUTION SYSTEMS.

2. ALL WORK SHALL CONFORM TO THE REQUIREMENTS OF THE 2020 BUILDING CODE of NEW YORK STATE, THE NATIONAL ELECTRICAL CODE, NFPA NO, 70-2017 (NEC), LOCAL UTILITY STANDARDS, OCCUPATIONAL SAFETY AND HEALTH CAT (OSHA), THE NATIONAL ELECTRICAL MANUFACTURERS' ASSOCIATION (NEMA) AND ANY OTHER APPLICABLE CODES. IN THE EVENT OF CONFLICT, THE MORE STRINGENT
REQUIREMENTS WILL APPLY.

3. ALL PRODUCTS USED FOR ELECTRICAL WORK SHALL BEAR THE UNDERWRITERS
LABORATORIES, INC. LABEL AND BE SUITABLE FOR THE ENVIRONMENT IN WHICH THEY

WILL BE INSTALLED.

4. ALL WORK ON THE ELECTRICAL SYSTEM SHALL BE PERFORMED BY OR UNDER THE SUPERVISION OF A PROPERLY LICENSED MASTER ELECTRICIAN.

5. THE CONTRACTOR SHALL OBTAIN, SUBMIT, AND PAY FOR ALL PERMITS, LICENSES AND INSPECTIONS AS REQUIRED BY THE LOCAL, STATE, AND FEDERAL AUTHORITIES, AND ANY OTHER APPLICABLE JURISDICTION. AND ANY OTHER APPLICABLE JURISDICTION.

6. CARBON MONOXIDE DETECTORS IN CONFORMANCE WITH APPLICABLE CODES

SHALL BE CONNECTED TO THE LIGHTING CIRCUITS WITH NO INTERVENING WALL

SWITCH. LINE CORD-CONNECTED, DIRECT PLUG-IN, AND BATTERY POWERED ALARMS

ARE NOT ACCEPTABLE. ALARMS SHALL BE INSTALLED ON EACH LEVEL ON WHICH SLEEPING QUARTERS ARE LOCATED.

7. SMOKE DETECTORS IN CONFORMANCE WITH THE 2020 BUILDING CODE of NEW YORK STATE, THE NFPA NATIONAL FIRE ALARM CODE NO. 72-1993 SHALL BE PROVIDED OUTSIDE EACH SEPARATE SLEEPING AREA, IN EACH SPLEEPING AREA, AND

CONTRACTOR SHALL COORDINATE WITH OWNER'S ALARM COMPANY FOR SMOKE AND BURGLAR ALARMS AS NECESSARY.

CLIMATIC AND GEOGRAPHIC CRITERIA

GROUND SNOW LOAD 20 PSF (PER FIG. 1608.2 BCNYS 2020 WIND SPEED (ULTIMATE DESIGN) 130 MPH (PER FIG. 1609.3(1) BCNYS 2020 (PER SECT. 1613 BCNYS 2020 SEISMIC DESIGN CATAGORY B WINTER DESIGN TEMP (PER TABLE N1101.2) FLOOD ZONE (PER FEMA MAP)

SEVERE (PER BCNYS 2020 WEATHERING PROBABILITY DESIGN LOAD CALCULATIONS (UNIFORM LIVE LOADS)

PER TABLE 1607.1 BCNYS 2020 ROOMS OTHER THAN SLEEPING 40 PSI SLEEPING ROOMS ATTICS WITH LIMITED STORAGE 20 PSI ATTICS WITHOUT STORAGE 10 PSI

NAILING SCHEDULE


FROST LINE DEPTH

DNE AND TWO FAMILY DWELLINGS 20 5 SBC HIGH WIND EDITION) JOINT DESCRIPTION NUMBER OF COMMON NAILS						
3 3 D) 3 LED) 3	PER RAFTER PER JOIST EACH LAP EACH LAP PER TIE					
2-8d 2-16d	EACH END EACH END					
2-16d 4-16d 2-16d 16d 2-16d,3-16d,4-16	PER FOOT JOIST EA.SIDE 24"O.C. 16"O.C.ALONG EDGES PER 2x4,2x6,2x8 RESPECTIVELY PER FOOT					
ED) 4-8d 2-8d 2-8d 3-16d 3-16d 3-8d 3-16d) 2-16d	PER JOIST EACH END EACH END EACH BLOCK EACH JOIST PER JOIST PER JOIST PER FOOT					
8d 2-8d 3-8d	(TABLE 3.8) PER SUPPORT PER SUPPORT					
5d coolers	7"EDGE / 10" FIELD					
8d	(TABLE 3.9)					
8d 8d 5d coolers 8d 8d 2-8d 3-8d	3"EDGE / 6" FIELD 3"EDGE / 6" FIELD 7"EDGE / 10" FIELD (TABLE 3.9) (TABLE 3.9) PER SUPPORT PER SUPPORT					
8d 10d	G"EDGE / 2" FIELD G"EDGE / G" FIELD					
	MIND EDITION) MBER OF COMMON NAILS 3 3 3 D) 3 LED) 3 2 2-8d 2-16d 4-16d 4-16d 16d 2-16d,3-16d,4-16 2-16d 8-16d 3-8d 3-16d 3-8d 3-16d 3-8d 3-16d 3-8d 3-16d 5-16d 8-16d					

2-8d


PER SUPPORT

PER SUPPORT

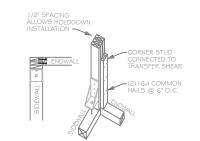


CORNER

I "x I O" OR WIDER

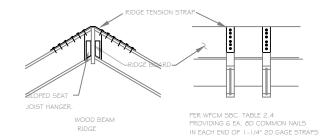


RIDGE CROSS SECTION

END VIEW

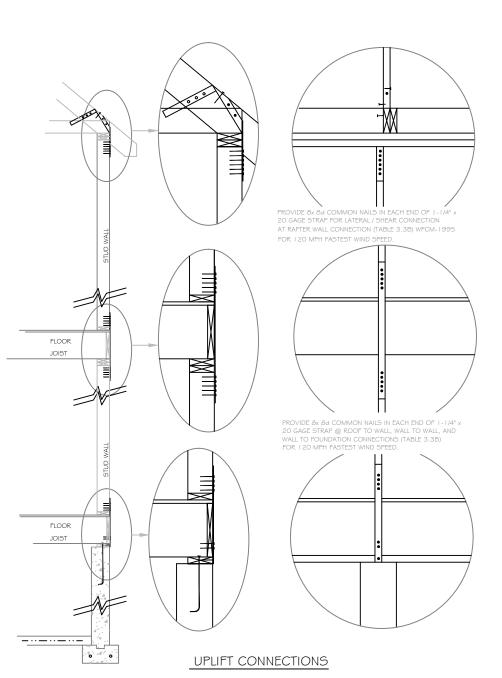

CONNECTIONS DETAIL

FROM TABLE N 102.1.2 (R402.1.2) INSULATION AND FENESTRATION REQUIREMENTS BY COMPONENT										
CLIMATE ZONE	FENESTRATION U-FACTOR	SKYLIGHT U-FACTOR	GLAZED FENESTRATIN SHGC	CEILING R-VALUE	WOOD FRAME WALL R-VALUE	MASS WALL R-VALUE	FLOOR R-VALUE	BASEMENT WALL R-VALUE	SLAB R-VALUE \$ DEPTH	CRAWL SPACE WALL R-VALUE
4	0.32	0.55"	0.40	49	20 OR 13+5	8/13	19	10/13	10, 2FT	10/13

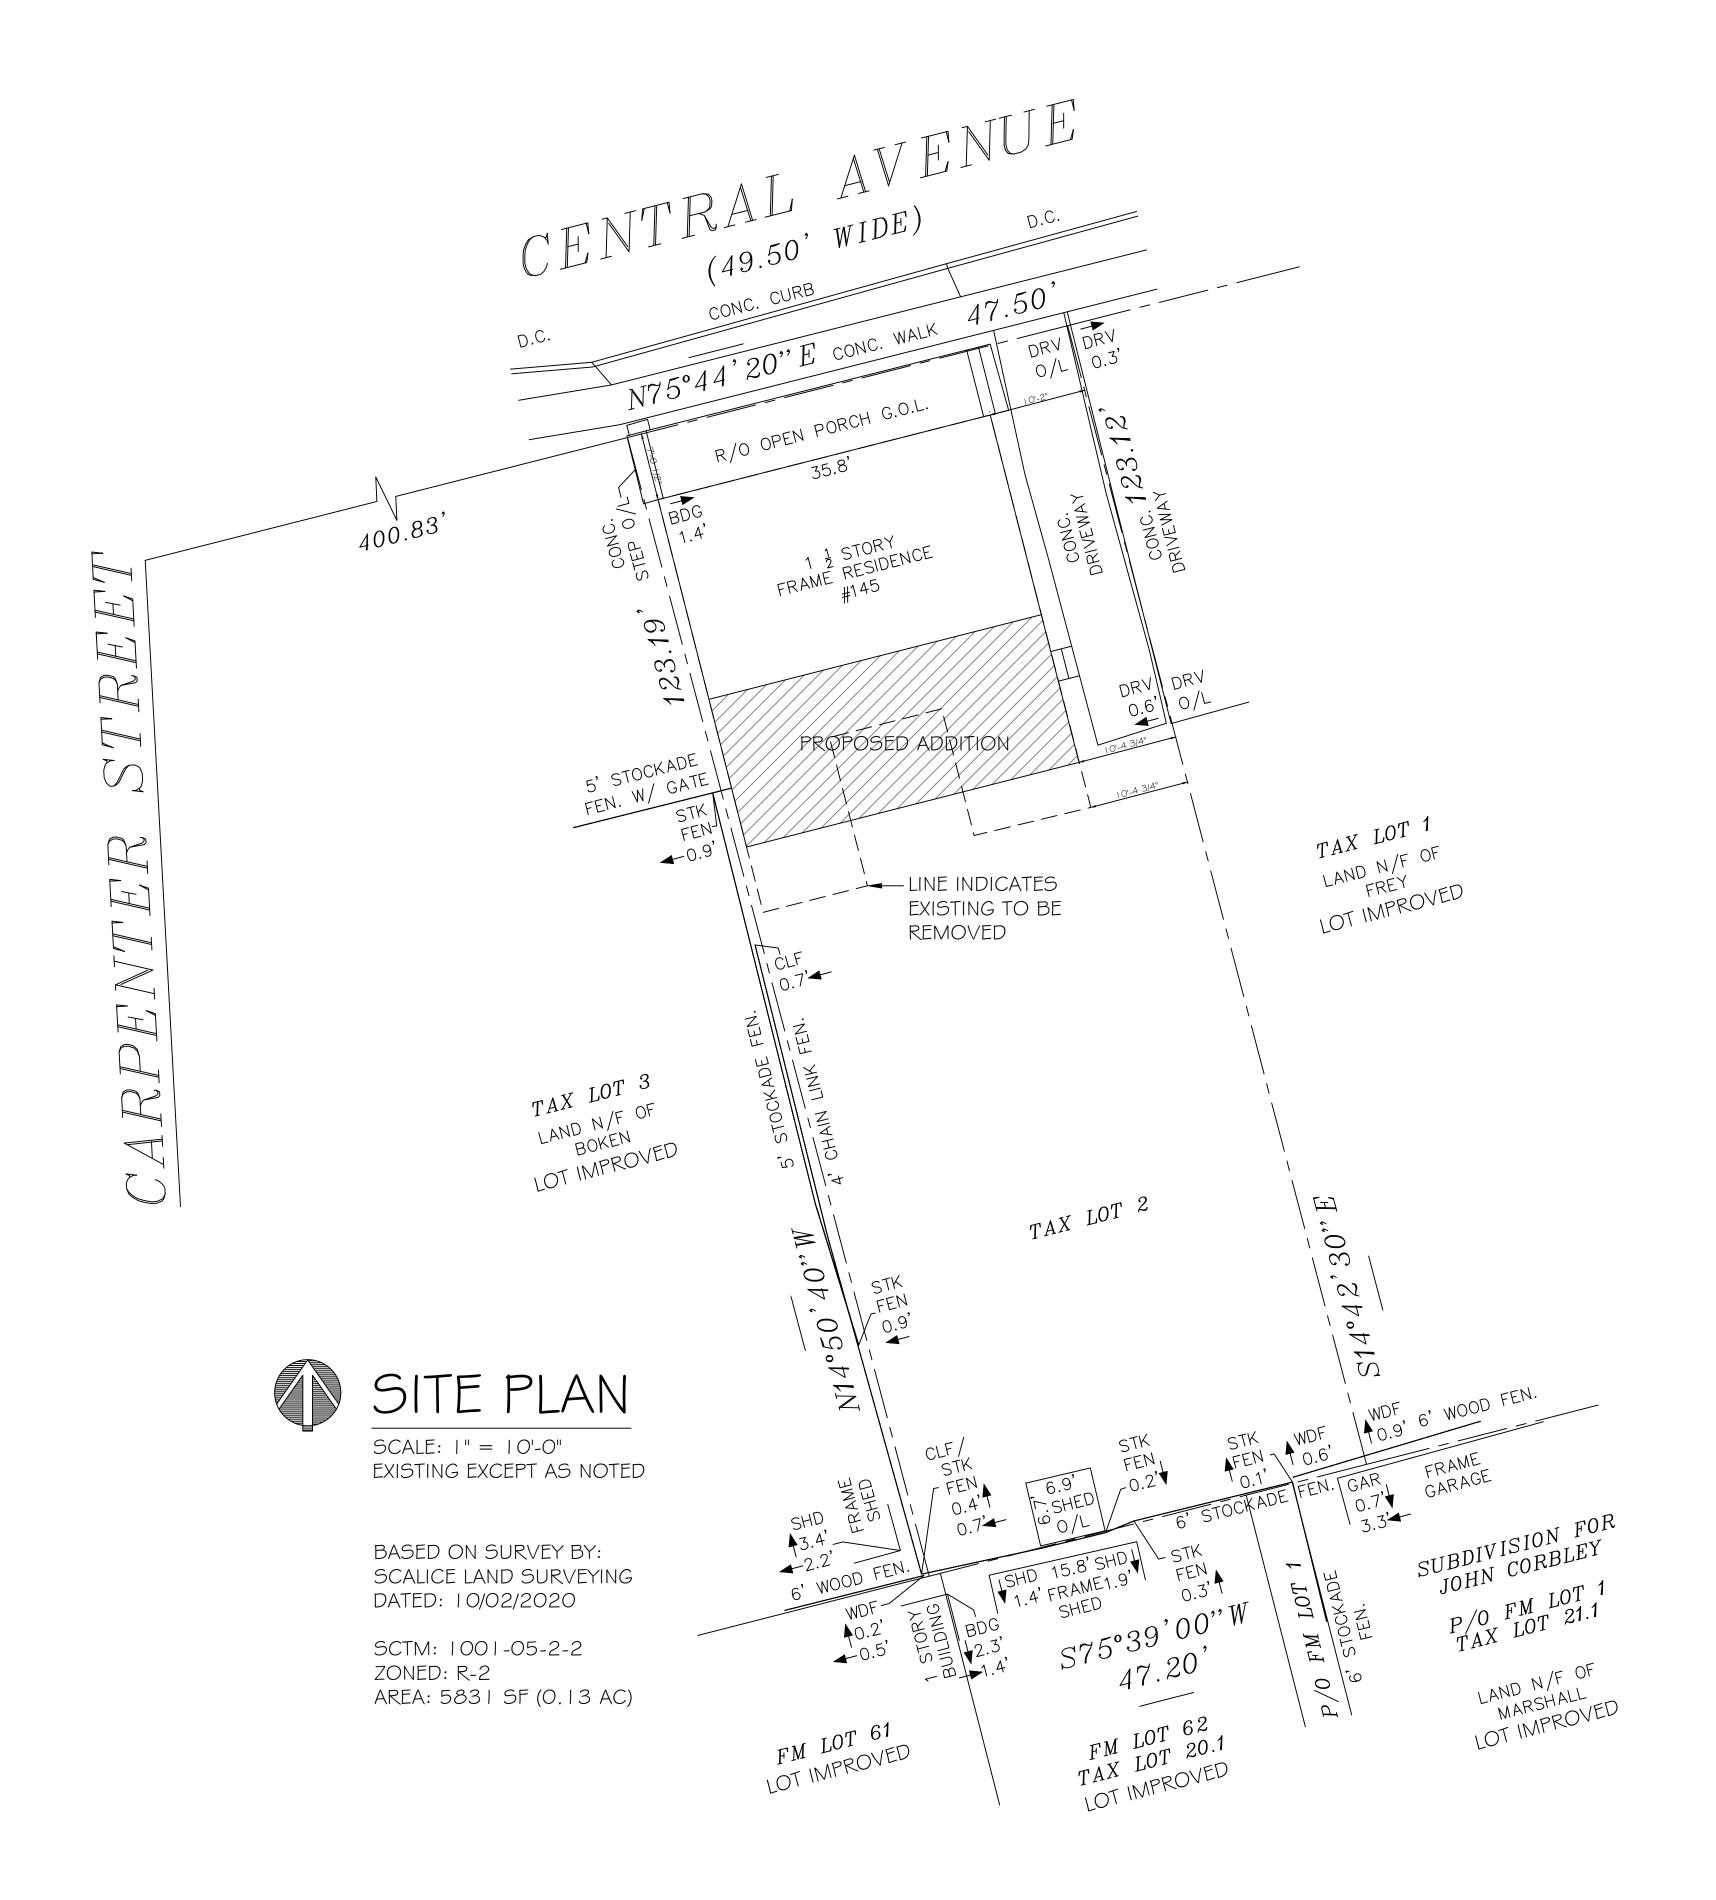

01 OCTOBER, 2021

ISSUES / REVISIONS

26 AUGUST, 2021 17 AUGUST, 2021

12 AUGUST, 2021

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CLIENT / OWNER

INNAMORATO TOM

145 CENTRAL AVENUE GREENPORT, NY 11944

PROJECT TITLE

ADDITIONS AND RENOVATIONS


DRAWING TITLE


SITE PLAN **GENERAL NOTES**

08 OCTOBER, 2021

DRAWING NO.

SCALE 1" = 10'-0"

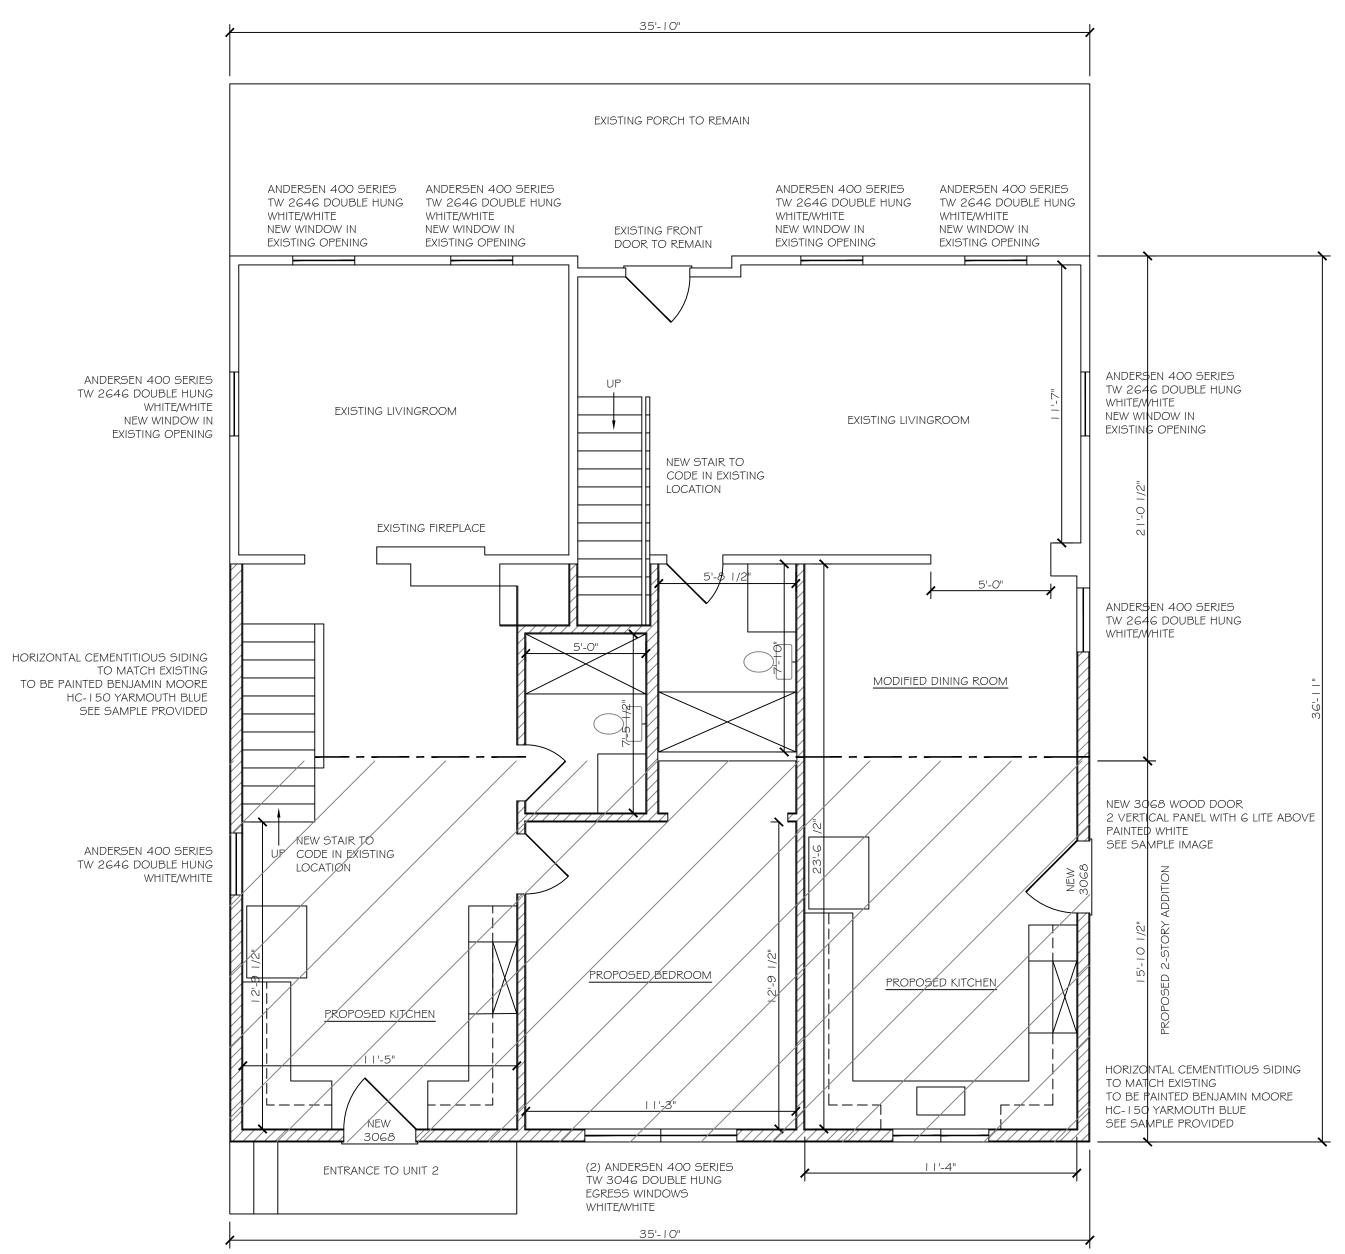

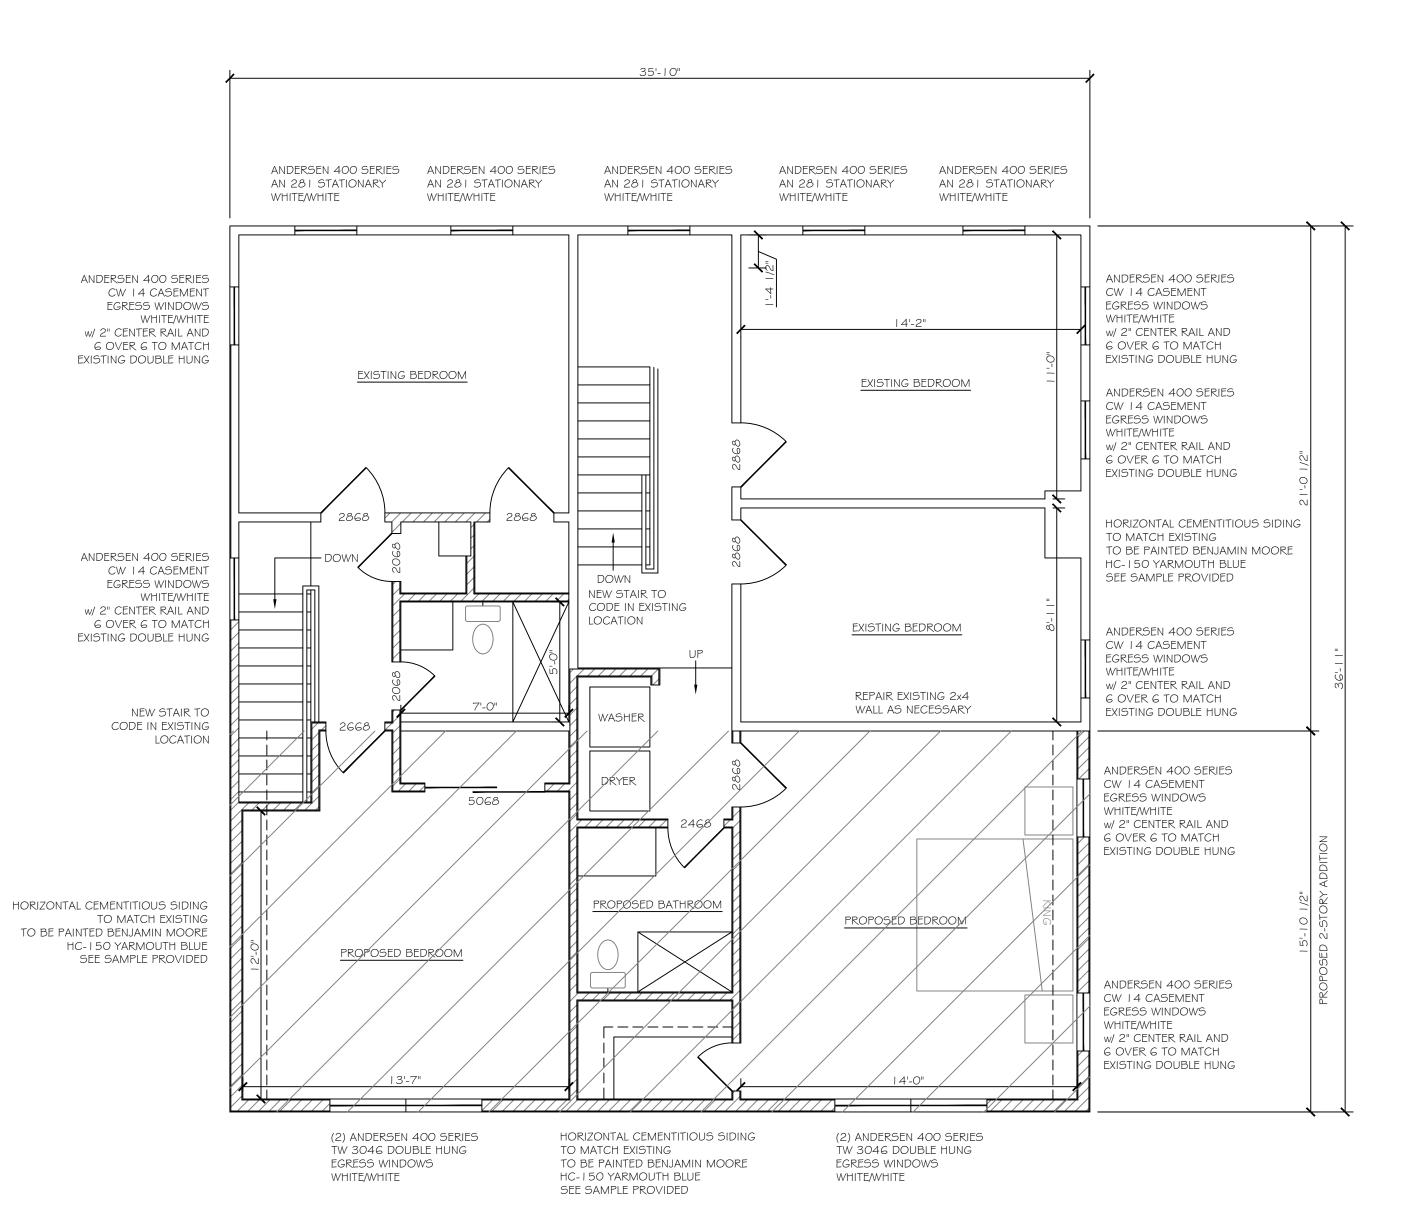

FIRST FLOOR PLAN

SCALE: 1/4" = 1'-0"
EXISTING EXCEPT AS NOTED

PROPOSED WALLS

EXISTING WALLS

SECOND FLOOR PLAN

SCALE: 1/4" = 1'-0"
EXISTING EXCEPT AS NOTED



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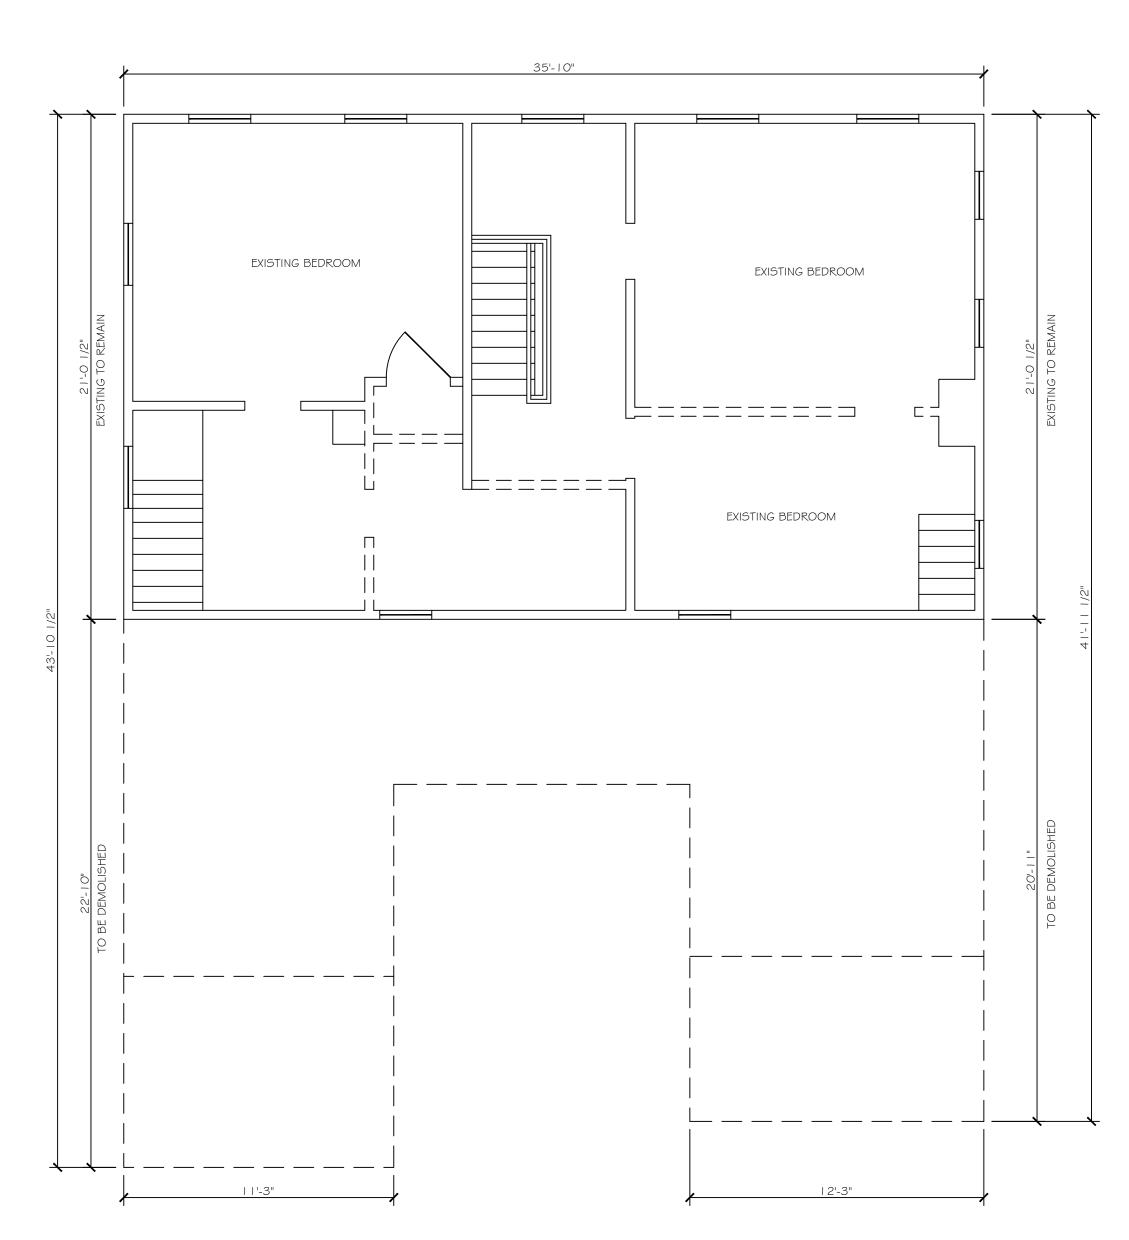
FLOOR PLANS

08 OCTOBER, 2021


DRAWING NO.

SCALE 1" = 20'-0"

A2





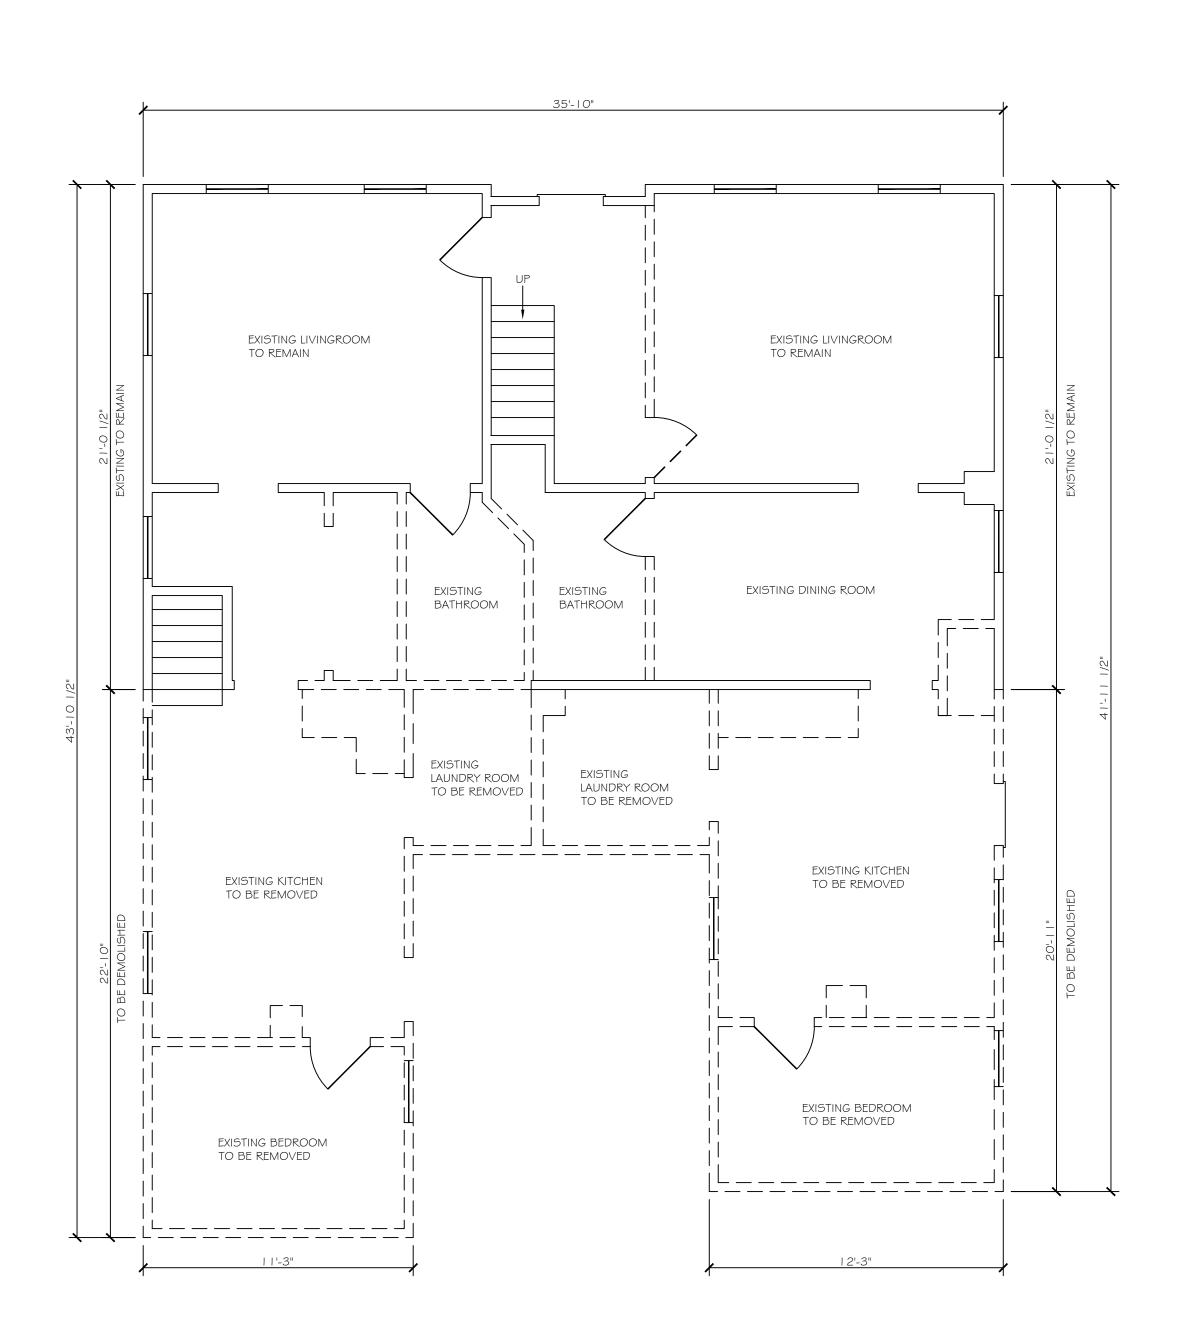

FIRST FLOOR DEMOLITION PLAN SCALE: 1/4" = 1'-0" EXISTING EXCEPT AS NOTED

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INNAMORATO

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PROJECT TITLE

ADDITIONS AND RENOVATIONS

DRAWING TITLE

DEMOLITION PLANS

08 OCTOBER, 2021

DRAWING NO.

SCALE 1/4" = 1'-0"




PROPOSED NORTH ELEVATION (FRONT)

SCALE: 1/4" = 1'-0" EXISTING EXCEPT AS NOTED



PROPOSED SOUTH ELEVATION (REAR)

SCALE: 1/4" = 1'-0" EXISTING EXCEPT AS NOTED

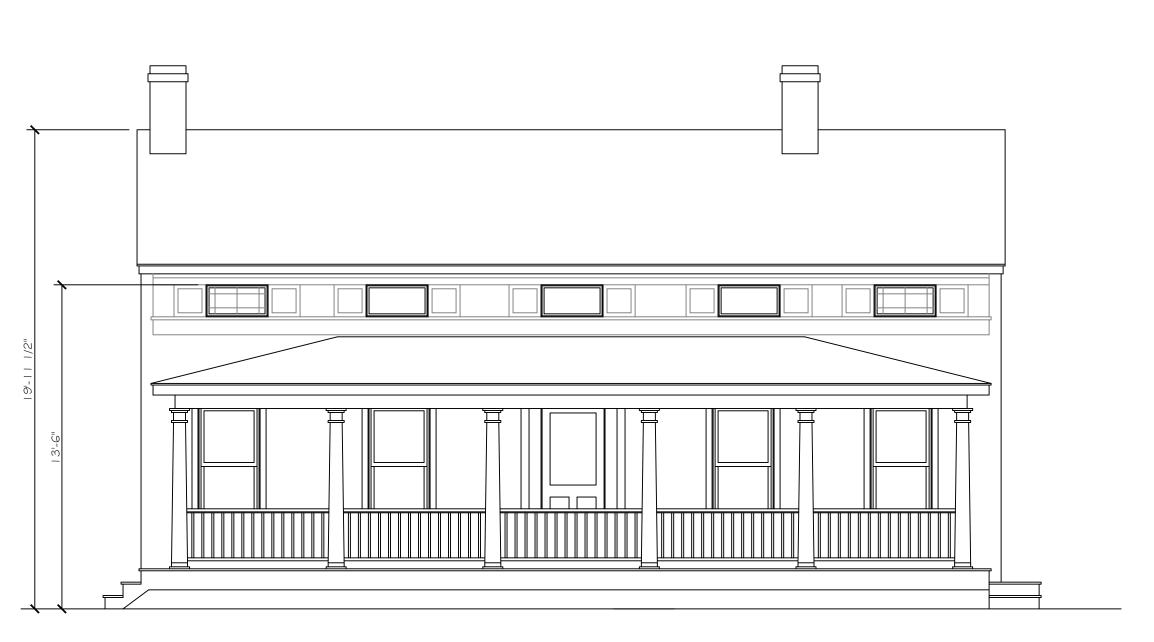

EXISTING NORTH ELEVATION (FRONT)

SCALE: 1/4" = 1'-0" EXISTING EXCEPT AS NOTED



EXISTING SOUTH ELEVATION (REAR)

SCALE: 1/4" = 1'-0" EXISTING EXCEPT AS NOTED 01 OCTOBER, 2021

26 AUGUST, 2021

17 AUGUST, 2021

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INNAMORATO TOM

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ADDITIONS AND RENOVATIONS

DRAWING TITLE


ELEVATIONS

08 OCTOBER, 2021

DRAWING NO.

SCALE 1/4" = 1'-0"

A4

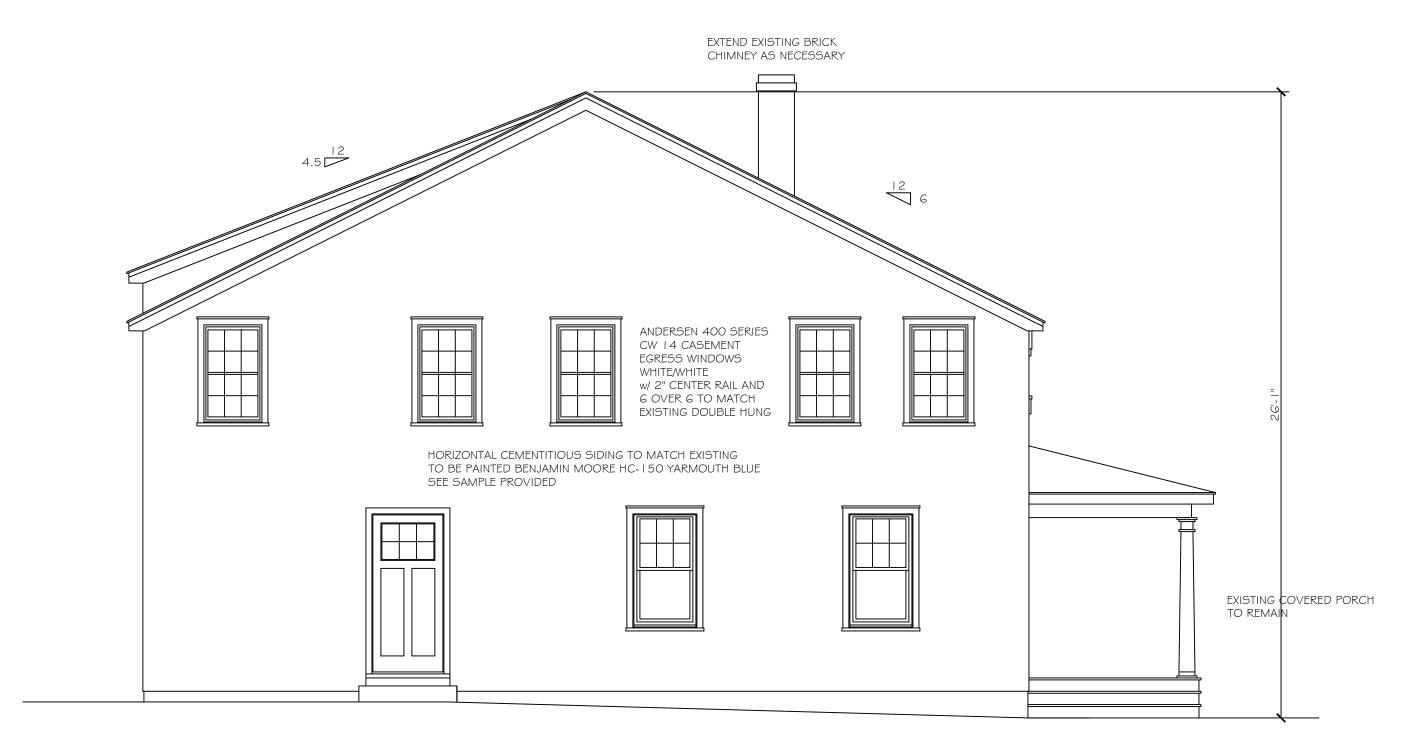


PROPOSED SIDE ELEVATION (EAST)

SCALE: 1/4" = 1'-0" EXISTING EXCEPT AS NOTED



NEW SIDE DOOR (EAST SIDE) AND NEW REAR APARTMENT DOOR (SOUTH SIDE), PAINTED WHITE

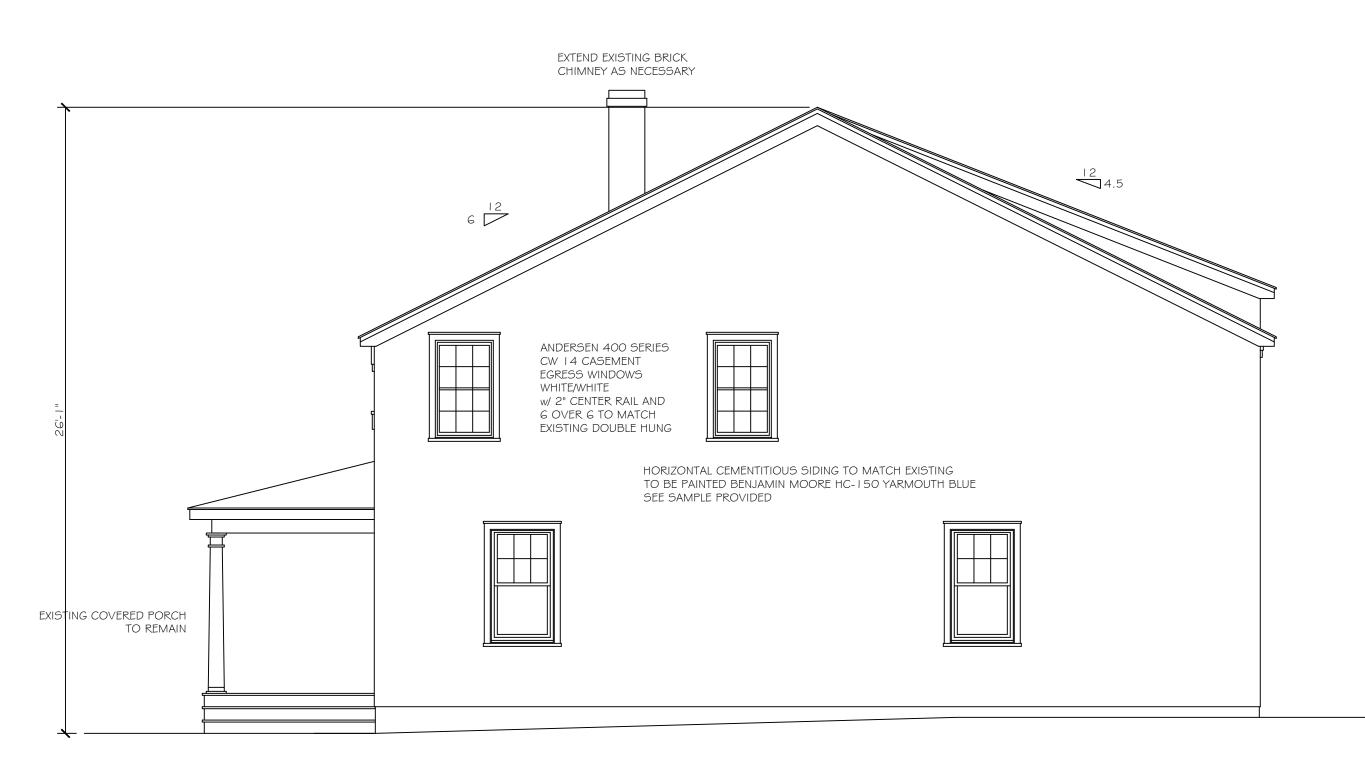

PROPOSED SIDE ELEVATION (WEST)

SCALE: 1/4" = 1'-0" EXISTING EXCEPT AS NOTED



CASEMENT WINDOWS MULLED TO

LOOK LIKE EXISTING DOUBLE HUNG

PROJECT WILL HAVE 6 OVER 6 TO

PAINTED WHITE TO MATCH EXISTING

MATCH EXISTING WINDOWS,

EXISTING SIDE ELEVATION (EAST)

SCALE: 1/4" = 1'-0" EXISTING EXCEPT AS NOTED



DOUBLE HUNG PICTURE CASEMENT



EXISTING SIDE ELEVATION (WEST)

SCALE: 1/4" = 1'-0" EXISTING EXCEPT AS NOTED

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DRAWING TITLE

ELEVATIONS

08 OCTOBER, 2021

DRAWING NO.

SCALE 1/4" = 1'-0"