GREENPORT, NY

## SCHEMATIC DESIGN

THE TURETT COLLABORATIVE

277 BROADWAY, SUITE 1300 NEW YORK, NY, 10007 212.965.1244

#### SHEET LIST

T-000 COVER SHEET Z-001 EXISTING SURVEY Z-002 G-001 NEW PROPOSED SITE PLAN GENERAL NOTES G-002 SYMBOLS AND ABBREVIATIONS A-101 CONSTRUCTION PLAN - LEVEL 1 CONSTRUCTION PLAN - LEVEL 2 A-102 A-103 A-201 CONSTRUCTION PLAN - ROOF BUILDING ELEVATIONS - NORTH & SOUTH A-202 A-301 A-302 A-601 BUILDING ELEVATIONS - EAST & WEST BUILDING SECTION BUILDING SECTION B PARTITION TYPES A-602 PARTITION TYPES CONT.

DOOR AND WINDOW SCHEDULE

225 MONSELL PLACE

ISSUE/REVISION

DATE 08/04/2021

#### CONSULTANTS

ARCHITECT THE TURETT 277 BROADWAY, SUITE 1300 NEW YORK, NY, 10007 212.965.1244

STRUCTURAL ENGINEER

XXXX XXXX XXXX XXXX

MECHANICAL ENGINEER XXXX XXXX XXXX XXXX

THE TURETT COLLABORATIVE;

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DRAWING TITLE

**COVER SHEET** 

AUG 0 2 2022

RECEIVED

VILLAGE OF GREENPORT BUILDING DEPARTMENT



PROJ. NO.: 2018 DATE: 01/22/2020 SCALE: SHT. NO.:

#### **GENERAL NOTES**

- THE CONSTRUCTION MANAGERIGENERAL CONTRACTOR SHALL VERIFY ALL EXISTING CONDITIONS IN THE FIELD PRIOR TO COMMENCING WORK, AND SHALL REPORT ANY DISCREPANCIES BETWEEN DRAWINGS AND FIELD CONDITIONS TO THE ARCHITECT.
- MINOR DETAILS NOT USUALLY SHOWN OR SPECIFIED, BUT NECESSARY FOR PROPER CONSTRUCTION OF ANY PART OF THE WORK SHALL BE INCLUDED AS IF THEY WERE INDICATED IN THE DRAWNIGS.

  THE GENERAL CONTRACTOR SHALL COORDINATE ALL WORK PROCEDURES WITH REQUIREMENTS OF LOCAL AUTHORITIES.
- ALL DIMENSIONS ARE FROM FINISHED WALLS AND PARTITIONS UNLESS OTHERWISE INDICATED. WRITTEN DIMENSIONS TAKE PRECEDENCE OVER SCALED DIMENSIONS, WALLS SHOWN TO "ALIGN SHALL BE FINISHED FLUSH AND SMOOTH WITH EXISTING WORK, AFTER THE PARTITION WALLS HAVE BEEN LAD OUT THE ARCHITECT IS TO BE NOTIFIED SO THAT WORK MAY BE INSPECTED AND APPROVED FOR CONFORMANCE WITH DESIGN BEFORE PROCEEDING WITH ADDITIONAL
- CONSTRUCTION.
  ALL WORK TO BE COORDINATED BY GENERAL CONTRACTOR UNLESS OTHERWISE NOTED. ANY SUBSTITUTE IN 
  SPECIFICATIONS MUST BE SUBMITTED TO THE ARCHITECT FOR APPROVAL SHOULD THE CONTRACTOR FIND ANY 
  DISCREPANCIES. OMISSIONS, AMBIGUITIES, OR CONFLICTS IN ANY OF THE CONSTRUCTION DAMINISS, OR BE 
  DOUBT AS TO THEIR MEANING. THEY MUST BRING THE QUESTION TO THE ATTENTION OF THE ARCHITECT PRIOR TO 
  START OF CONSTRUCTION. THE ARCHITECT SHALL REVIEW THE QUESTION AND WHERE INFORMATION SOUGHT IS NOT 
  CLEARLY INDICATED OR SPECIFICIE. WILL ISSUE A CURITYING ADDENOUN. NEITHER THE OWNER NOR THE ARCHITECT 
  WILL BE RESPONSIBLE FOR VERBAL INSTRUCTIONS.
- WRITTEN REQUEST MUST SUBMITTED FOR ANY PROPOSED CHANGES IN SCOPE OF THE WORK BY THE GENERAL CONTRACTOR TO THE CLIENT AND ARCHITECT BEFOR ANY WORK IS STARTED, SUCH REQUESTS SHALL INDICATE SCOPE OF WORK OST, AND POSSBLE DELAYS FOR THE PROJECT.
- SCOPE OF WORK, CUST, AND PUSSIBLE BUEATS TO THE PROJECT.

  THE GENERAL CONTRACTOR SHALL BE RESPONSIBLE FOR PROTECTION OF ALL CONDITIONS AND MATERIALS WITHIN THE PROPOSED CONSTRUCTION AREA AND ALL COMMON SPACES LEADING TO AND FROM THE CONSTRUCTION AREA GENERAL CONTRACTOR SHALL HAVE SOLE RESPONSIBILITY FOR ANY DAMAGE OR INJURIES CAUSED BY OR DURING

THE DRAWINGS MAY NOT SHOW ALL ITEMS OR OBJECTS EXISTING AT THE SITE. THE CONTRACTOR MUST VERIFY AT THE SITE ALL OBJECTS TO BE PRESERVED AND REPORT TO THE ARCHITECT ANY DISCREPANCIES OR QUESTIONABLE

THE SITE PALL OBJECTS TO BE FRESHMEND AND HEAVITH THE SITE PALL OBJECTS OF SIGNED TO REMAIN AND IN THE EVENT OF DAMAGE. IMMEDIATELY MAKE ALL REPAIRS AND REPLACEMENT NECESSARY TO THE APPROVAL OF THE ARCHITECT AT NO ADDITIONAL EXPENSE TO THE OWNER.

PRIOR TO COMMENCEMENT, CAREPULLY INSPECT THE ENTIRE SITE AND ALL OBJECTS DESIGNATED TO BE REMOVED AND TO BE PRESERVED. AS WELL AS ALL EXISTING UTILITIES THE GENERAL CONTRACTOR SHALL REMOVE. REPORTED OF ALL PRINCIPLES UTILITIES AFTER CHECKING WITH THE ARCHITECT. THESE ITEMS SHALL BE CAPPED OFF WITHIN EXISTING WALLS OR FLOORS.

CAPPED OF WITHIN EAD IND WALLD OF CLOURS.

ALL CUTSIDE CORNERS AT MASONRY AND DRYWALL PARTITIONS SHALL HAVE METAL CORNER BEADS. TAPE AND SPACKLE SMOOTH WHERE REQUIRED. THREE COAT SPACKLE FINSH MIRI.

B. ALL DEPECTIVE PLASTER ANDORD ORWINGLE ON ADJACENT EXISTING WALLS SHALL BE CHOPPED OUT ANDIOR PATCHED FREE OF IRREQUILABITIES AND SHALL MATCH ADJACENT WALLS IN FINISH AND THICKNESS.

C. ALIGNMENT OF NEW WALL CONSTRUCTION TO DESTRING WALLS AND COLLIMIS SHALL BE DONE IN A MANNER AS TO WISBLY ELIMINATE THE POINT OF CONTACT OR JOINT OF NEW AND DOSSTING MATERIALS.

WHEED PLAST INDOM MAS OF CORRESPOND OF THE PROPERTY OF TH

DWHERE DEMOLITION HAS OCCURRED, CONTRACTOR SHALL FILL ALL HOLES, PATCH SMOOTH AND LEVEL ALL REMAINING SURFACES, INCLUDING WALLS FLOORS, AND CELINGS, SQUARE ALL CORNERS AND PROPERLY PREPARE ALL SURFACES TO RECEIVE PRINSHES

CLEAN UP: THE GENERAL CONTRACTOR SHALL KEEP THE SITE FREE FROM ACCUMULATION OF MATERIAL AND DEBRIS. CLEAN UP: THE OBJECTAL CONTRACTION SHALL KEEP THE SITE FREE FROM ACCUMULATION OF MATERIAL AND DEBRIS. PREMISES SHALL BE LEFT BROOM CLEAN AT THE CLOSE OF EVERY WORK DAY. CONTRACTORS MUST FROWDE THEIR OWN DUMPSTERS ALL BE LEFT BROOME THEIR FOR THE DAY MAY DEBRIS AS THE COMPACTOR SHALL BE RESPONSIBLE FOR THE REMOVAL OF ALL UNIWANTED EQUIPMENT AND DEBRIS AT THE COMPLETION OF CONSTRUCTION. AT THE COMPLETION OF THE WORK, THE GENERAL CONTRACTOR SHALL BE RESPONSIBLE FOR THE REMOVAL OF ALL UNIWANTED EQUIPMENT AND DEBRIS AT THE COMPLETION OF CONTRACTOR SHALL BE RESPONSIBLE. FOR THE REMOVAL OF ALL UNIWANTED EQUIPMENT AND DEBRIS AT THE COMPLETION OF CONTRACTOR SHALL PREFORM THE FOLLOWING CLEANING.

A CLEAN FIXTURES, EQUIPMENT. FINISH HARDWARE, PAINTED AND DECORATED SURFACES, AND REMOVE MARKS, STAINS, PAINT, DIRT, AND OTHER SOILING RESULTING FROM THE WORK OF THIS CONTRACT.

STAINS, PAINT, DIRT, AND OTHER SOILING RESULTING FROM THE WORK OF THIS CONTRACT.

PIRE SAFETY,

ALL BUILDING MATERIALS STORED AT CONSTRUCTION AREA ARE TO BE SECURED IN A LOCKED AREA WITH ACCESS

CONTROLLED BY THE GOWER HONOIG GENERAL CONTRACTOR.

ALL MATERIAL RO BE STORED IN AN ORDERLY FASHON.

ALL FLAMMABLE MATERIALS RET OB EXERT TO INFLITY SEALED IN THEIR ORIGINAL CONTAINERS, SUCH MATERIALS

SHALL BE KEPT AWAY FROM HEAT OR OPEN IF AMES.

ALL FLAMMABLE MATERIALS TO BE USED AND STORED IN AN ADEQUATELY VENTILATED SPACE.

ALL ELECTRICAL POWER IN THE CONSTRUCTION AREA IS TO BE SHUT OFF ATTERN WORKING HOURS.

GENERAL CONTRACTOR AT ALL TIMES SHALL MAKE SURE THERE IS NO LEARAGE OF NATURAL GAS IN BUILDING, OR

ANY OTHER TRAMMABLE GAS USED IN CONSTRUCTION.

## PLUMBING NOTES

- ALL PLUMBING WORK SHALL BE PERFORMED BY A LICENSED PLUMBER
- PLUMBER MUST CHECK EXISTING WASTE AND VENT LINES TO BE FREE OF OBSTRUCTION.
- PROVIDE NEW ISOLATION VALVES AND BRANCH LINES FOR HOT AND COLD WATER SUPPLY FOR RENOVATED BATHROOMS AND KITCHEN, ALL NEW COPPER PIPING SHALL BE PROVIDED FROM THE ISOLATION VALVE TO EACH FIXTURE. ALL NEW SHUTOFF VALVES TO BE PROVIDED AT EACH FIXTURE.

## **ELECTRICAL NOTES**

1 ALL ELECTRICAL WORK SHALL BE PERFORMED BY A NY STATE LICENSED ELECTRICIAN AND ALL WORK SHALL BE IN ACCORDANCE WITH LOCAL JURISDICTION.

### CARBON MONOXIDE ALARM NOTES

1 CARBON MONOXIDE ALARMS SHALL BE INSTALLED AS REQUIRED BY R315-CARBON MONOXIDE ALARMS

## SMOKE DETECTOR NOTES (DWELLING UNITS)

- SMOKE DETECTORS SHALL BE INSTALLED AS REQUIRED BY R314 SMOKE ALARMS AND HEAT DETECTION.
- DETECTORS SHALL BE BITHER IONIZATION CHANGERS OR PHOTOELECTRIC TYPES.

  UNITS TO BE APPROBED BY BOARD OF STANDARDS AND APPELS SACCEPTED PURSUANT TO RULES AND

  REQULATIONS PROMULGATED BY THE COMMISSIONER OR LISTED BY AN ACCEPTABLE TESTING LAGORAT

UNDERWRITER'S LABORATORY, NORTHBROOK, ILLINOIS, MEA LAB.; CANADIAN STANDARD ASSOCIATION, ONTARIO, CANADA, UNDERWRITER'S LAB. OF CANADA, ONTARIO, CANADA, MEA, LAB.

- 4 UNITS SHALL BE INSTALLED IN AREAS DESIGNATED ON PLANS, THEY SHALL BE LOCATED ON OR NEAR THE CEILINGS AND WITHIN 15-7 OF ANY ROOMS USED FOR SLEEPING PURPOSES, FOR DWELLING UNITS WITH MULTIPLE LEVELS. WHEN ANY LEVEL HAS ONLY ONE MEANS OF GERESU, NITS SHALL BE PROVIDED AT ALL LEVELS.
- 5 UNITS SHALL BE INSTALLED IN AREAS DESIGNATED ON PLANS. INFO SHALL BE PROVIDED AT ALL EVELS.
  AND WITHIN 15-0'C ANY ROOMS USED FOR SLEEPING PURPOSES, FOR DWELLING UNITS WITH MULTIPLE LEVELS.
  WHEN ANY LEVEL HAS ONLY ONE MEANS OF GRESS, UNITS SHALL BE PROVIDED AT ALL EVELS.

#### **BUILDING CODE NOTES**

1 ALL CONSTRUCTION WORK SHALL BE DONE IN ACCORDANCE WITH REQUIREMENTS OF THE FOLLOWS:

-2020 RESIDENTIAL CODE(RC) CODE OF NEW YORK STATE -2020 ENERGY CONSERVATION CONSTRUCTION CODE OF NEW YORK STATE (ECCCNYS) -2020 ENSTRNO BUILDING CODE OF NEW YORK STATE -SOUTHOLD TOWN CODE

- SOUTHOLD TOWN CODE

  PERR CO OF NEW YORK STATE R102.7.1 ADDITIONS, ALTERATIONS OR REPAIRS TO ANY STRUCTURE SHALL CONFORM TO
  THE REQUIREMENTS FOR A NEW STRUCTURE WITHOUT REQUIRING THE DISTING STRUCTURE TO COMPLY WITH THE
  REQUIREMENTS OF THE CODE. ADDITIONS, ALTERATIONS, REPAIRS AND RELOCATIONS SHALL NOT CAUSE AN EXISTING
  STRUCTURE. TO SECONIE UNDER OR ADVESSLY AFFECT THE PERFORMANCE OF THE BUILDING.
  ALL ELECTRICAL WORK TO CONFORM TO LOCAL, STATE, AND N.E.C. AND UNDERWRITERS REQUIREMENTS.
- ALL PLUMBING TO CONFORM TO LOCAL AND STATE CODES AND HEALTH DEPARTMENT REQUIREMENTS.
- ALL FRAMING TO CONFORM THE INTERNATIONAL BUILDING CODE, FOR HIGH WIND ZONE 3, 120 MPH, 3 SECOND GUST.
  SITE EXPOSURE B. ALL FRAMING HARDWARE TO BE SUMPSON STRONG-TIE WITH A CONTINUOUS LOAD TRANSFER PATH
  FROM THE RAFTERS TO THE FOUNDATION. SHEATHING MUST EE SHALLE TO TOP PLATE, OTHER PLATES, ALL STUD AND
  HEADERS, ROOF RAFTERS TO BE CLIPPED ACROSS THE PLATE TO THE STUD.

-FOOTING AND FOUNDATION INSPECTION -FRAMING AND ROUGH-IN INSPECTION

THE CONTRACTOR SHALL NOTIFY THE CODE OFFICIAL WHEN WORK IS READY FOR INSPECTION, AND SHALL PROVIDE ACCESS TO AND MEANS FOR INSPECTIONS.

#### **ENERGY CODE NOTES**

- (U.O.N., ALL CODE SECTIONS REFERENCED REFER TO 10 ECCONYS).

  TO THE BEST OF MY KNOWLEDGE, BELIEF AND PROFESSIONAL JUDGEMENT, THESE PLANS AND SPECIFICATIONS ARE IN COMPLIANCE WITH THE ENERGY CONSERVATION CONSTRUCTION CODE OF NEW YORK STATE (ECCCNYS).

  ALSO SEE THE ENERGY CODE ANALYSIS CHART.

- ALL ALTERATIONS WORK SHALL COMPLY WITH 2020 NYSECCC.
- ALL AL IERAHIONS WORK SHELL COMMY WITH 2020 MYSECCC.

  PER ECCON'S SECTION 803.1, A L'ERRATIONS SHALL CONFORM TO ENERGY CODE REQUIREMENTS WITHOUT REQUIRING THE UNALTERED PORTIONS OF THE EXISTING BUILDING OR EXISTING SYSTEM TO COMPLY, ALTERATIONS SHALL NOT CREATE AN UNSAFE OR HAZARQUOS CONDITION OR QVERICADE EXISTING BUILDING SYSTEMS.

  ALTERATIONS SHALL BE SUCH THAT THE EXISTING BUILDING USES NOT MORE ENERGY THAN PRIOR TO ALTERATIONS.
- PER 907.1 OF EXISTING BUILDING CODE OF NEW YORK STATE, LEVEL 3 ALTERATIONS TO EXISTING BUILDINGS OR STRUCTURES ARE FERMITTED WITHOUT RECURRING THE ENTIRE BUILDING OR STRUCTURE TO COMPLY WITH THE ENERGY REQUIREMENTS OF THE ECCCNYS. THE ALTERATIONS SHALL CONFORM TO THE ENERGY REQUIREMENTS OF THE ECCONYS AS THEY RELATE TO NEW CONSTRUCTION ONLY.
- FR RIOR, REQUIRED EXERGY CODE INSPECTIONS INCLUDE:
  -FRAMING AND ROUGH-IN INSPECTION
  -PLUMBING AND ROUGH-IN INSPECTION
  -FINAL INSPECTION
  -FINAL INSPECTION
- THE CONTRACTOR SHALL NOTIFY THE CODE OFFICIAL WHEN WORK IS READY FOR INSPECTION, AND SHALL PROVIDE ACCESS TO AND MEANS FOR INSPECTIONS
- ACCESS TO AND JEANS FOR INSPECTIONS.

  PER 1833 1.1 AN R-VAULE DISTRIPCIONS.

  PER 1833 1.1 AN R-VAULE DISTRIPCION MARK SHALL BE APPUED BY THE MANUFACTURER TO EACH PIECE OF BUILDING THERMAE, ENVELOPE INSULATION THAT IS 12 INCHES OR GREATER IN WIDTH, A LTERNATELY, THE INSULATION INSTALLES BHALL PROVIDE A CERTIFICATION THAT INDICATES THE TYPE, MANUFACTURER AND R-VAULE ON INSULATION INSTALLED BHALL BE REPORTED THE BUILDING THE BUILDING THERMAL ENVELOPE FOR BLOWNIN OR SPRAYED FREEDRICALS AND CELLULOSE INSULATION, THE THAT INSTALLED DESIY, COVERAGE AREA AND NIABER OF BAGS INSTALLED SHALL BE INDICATED ON THE CERTIFICATION. FOR SPRAYED POLYURETHANE FORMSTALLED SHALL BE INDICATED ON THE CERTIFICATION. FOR SPRAYED POLYURETHANE FORMSTALLED SHALL BIS INDICATED ON THE CERTIFICATION. THE INSULATION, THE INSULATION, THE INSULATION IN ENTALLED THORSE SHALL BE NOCATED ON THE CERTIFICATION IN ECRIFICATION IN A COASPICUOUS LOCATION ON THE JOB SITE

  OFFE 8731 1.3 MAJAILE BUNTEMBLY ENTRYLLED THOSE CHARLES BE SIDENIES OF DE ORIGINETIA MAD SYSTEMS TO AND SYSTEMS TO AND SYSTEMS TO AND SYSTEMS THAT THE PROPERTY OF THE STANDARD SYSTEMS TO AND SYSTEMS THAT THE PART AND AND SYSTEMS TO A
- 10 PER R303.1.1. AN R-VALUE MAINTENANCE INSTRUCTIONS SHALL BE PURNISHED FOR EQUIPMENT AND SYSTEMS THAT REQUIRE PREVENTIVE MAINTENANCE, REQUIRED REQUIRE MAINTENANCE ACTIONS SHALL BE CLEARLY STATES AND INCORPORATED ON A REA
- 11 THE PERMANENT CERTIFICATE RE ENERGY EFFICIENT SHALL BE COMPLETED BY THE BUILDER OR OTHER APPROVED PARTY AND POSTED PER THE REQUIREMENTS OF ECCONYS R401.3.
- 12 AT CEILINGS WITHOUT ATTIC SPACES, R VALUE OF ROOF / CEILING INSULATION MAY BE REDUCED TO R-30 AS PER R402.2.2 AND LIMITATIONS SET FORTH IN THAT SECTION.
- 13 PER RIVEZ A, RECESSED LUMINARES INSTALLED IN THE BUILDING THERMAL ENVELOPE SHALL BE SEALED TO LIMIT AIR LEAVAGE BETWEEN CONDITIONED AND UNCONDITIONED SPACES, AND SHALL BE IC-RATED AND LIMELED AS HAVING AND AIR LEAVAGE OF ON'T GREATER THAN 2.0 CPM WHITE TESTED IN ACCORDANCE WITH ASTM E283 AT A PRESSURE DIFFERNTAL OF 1.57 PSF. RECESSED LUMINARES SHALL BE SEALED WITH A GASKET OR CAULAED SETWEEN THE HOUSING AND THE INTERIOR WALL OR CELLING COVERNIO.

THE CHART DEMONSTRATES COURT IN CE OF THIS PROJECT WIT ECCOURS:	HIMPLOHALE REQUIREMENTS OF THE 2001 ENERGY CONSERVATION CONSTRUCTION COCE OF NEW	YORK STATESCOOKS ALON ALL DODS SECTIONS REPREMIED PEFER	
BUILDING TYPE RESIDENTING			
CUMATE ZONE: 4A			
COMPLIANCE PRESCRIPTIVE - SECTIONS PROT THEOLOGISMAN			
ITEN DESCRIPTION	PROPOSED VALUE	ECCORYS PRESCRIBED VALUE	
CEL NO ROOF RIVALUE	R-SI (4" CLOSED CELL INSULATION (F-61 ADH - R-15 COMFINE BATT INSULATION	PER TABLE RICUIT 2 VIN 49	
DICCOD FRAME WALL RIVILLIE	NOSE (R23 ROCKADOL ESULATION - R SHEATHING (R234)	PER THEE REALT 2 VA. RISE COUNTY OR RATE (CAVITY) - RATE (CONTRACTOR)	
OCCUPATION AND CONTRACTOR AND CONTRA	Rif.	PER TABLE SIGN 12 NN 5-19	
CHANG SPACE WALL RIVALLE	813	#1	
FIDESTRATION UFFICTOR AND SOLURIVEAT GARL	PENESTRATION UFACTOR WAS U.O. 12	PER TABLE PAIZ 12 FEW STRATION UP ACTOR: MAX U-0.10	
	GLATED FENETRATION SHACE MAX. SHOC 0.45	FER TABLE AGES 1.2 GLAZED FENESTRATION SHOCK MAX. SHOCK 0.49	
MR-TENANCE	WHETE APPLICABLE AT AREAS OF NEW WITH, THE SULDING THEMAL EXPLICIT SHALL COMPAY WITH MALE AND LEAVING AND CHITERA AN ADDICATED IN THAT E ARCA LT. JOHNS, THE REPORT WISH ASSOCIATION OF THE SECURITY WASHING CHARGED GLORETTE, THETE IN APPROVIED MARKET TO WINNING AN LANCE.	FER TABLE RADIAL THE BUILDING THERMAL ENVISIONE SHALL LAST ARE LEWAGE IN ACCORDING WITH REQUIREMENTS OF SECTION RADIA A CRITICAL MODIATED IN TABLE RADIA 1.1	
	WINDOWS, SKYLISHTS AND SLICING DOORS DHALL HAVE AN AR HALLTRATION RATE OF NOT GREATER THAN OLD UTWINER SOLWE FOOT.	FER TABLE FACE 13, WINDOWS, SAVID-15 AND SLOPES DOORS SHALL HAVE AN ARROPD TRATION PAID OF HOT GREATER THAN 0.1 OF A FER	
Fidestration her lewace	DWINGING DOORS SHALL HAVE AN ART EMAKE OF NOT CREATER THAN 0.5 GRAFFS SOMER FOOT	SOLARE FOOT, MO FOR SYMBONG DOORS SHALL HAVE AN HIR LEMAN, OR NOT GREATER THAN IS STAMEDER SOLARE FOOT, WHEN TESTED IN ACCORDANCE WITH HIRO OF AMANY MANAGEMENT LESSANG BY AN ACCREDITED, INCREDIENT LINS, MID LISTED AND LINES ED BY THE	
	MAKEN TESTED AS NOTED IN THE MENT COLUMN IN	MARIACTURES	
DECTRICAL POMER AND LIGHTING SYSTEMS	NUT LESS THAN SOLLOF NEMPERANDENTLY INSTALLED LIGHTING FATURES DIALL CONTAIN ONLY HIGHEFT-DAYS LIMBS.	PER 7474.1 NOT LESS THAN ION OF YEN PERSAMENTLY INSTALLED UPPING FATURES THALL CONTAIN ONLY HONESTICACY LASTIS.	

225 MONSELL PLACE

ISSUE/REVISION

DATE

CONSULTANTS

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STRUCTURAL ENGINEER

XXXX XXXX XXXX

MECHANICAL ENGINEER

XXXX XXXX XXXX

> AV + IT CONSULTANT XXXX

XXXX XXXX

ACOUSTICAL CONSULTANT

XXXX XXXX XXXX

CONSULTANT 6 TYPE

XXXX XXXX XXXX

XXXX CONSULTANT 7 TYPE

XXXX XXXX XXXX

THE TURETT COLLABORATIVE:

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DRAWING TITLE

**GENERAL NOTES** 

STAMP & SIGNATURE PROJ. NO.:

2018 01/08/20 SCALE: SHT. NO .: G-001

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## ANNOTATION SYMBOLS LEGEND





EXTERIOR ELEVATION MARKER



ROOM TAG



SECTION HEAD



ENALRGED AREA CALLOUT



ELEVATION / DATUM MARKER

Œ

DOOR TAG CENTERLINE

(4)

PARTITION TAG

(1i)

 $\triangle$ 

WINDOW TAG

REVISION TAG

#### MATERIAL LEGEND



RIGID INSULATION

















WOOD PLANK

BRICK

ABBREVIATIONS LIST









225 MONSELL PLACE

ISSUE/REVISION

DATE

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STRUCTURAL ENGINEER XXXX XXXX XXXX XXXX

MECHANICAL ENGINEER XXXX XXXX

XXXX

XXXX

AV + IT CONSULTANT XXXX

XXXX ACOUSTICAL CONSULTANT XXXX XXXX

XXXX CONSULTANT 6 TYPE XXXX

XXXX XXXX

XXXX

CONSULTANT 7 TYPE XXXX XXXX

THE TURETT COLLABORATIVE:

DRAWING TITLE

## SYMBOLS AND **ABBREVIATIONS**



SCALE: As indicated SHT. NO .: G-002

AIR CONDITIONER UNIT ACOUSTIC CEILING TILE AREA DRAIN ABOVE FINISH FLOOR ADJACENT ADJUSTABLE ALUMINUM APARTMENT BASE CABINET BRICK COURSES BOILER FLUE BOTTOM OF SLAB BATHTUB BATH VENT (BATH EXHAUST) BOARD BUILDING BLOCK BEAM BOTTOM BRICK BETWEEN

CAULKED CONTROL JOINT

CONCRETE HARDENING

CORRUGATED METAL TIE

CONCRETE MASONRY UNITS COLUMN CONCRETE

CAST IRON SADDLE

CLEAN OUT

CAST STONE

CERAMIC TILE COLD WATER CABINET CAULKING

CEMENT CHAMBER CLOSET

CEILING

CONTINOUS

CONVECTOR

COUNTER

CARPET

ABBREVIATIONS LIST

DOUBLE LAYER DINING ROOM DWELLING UNIT DIAGONAL DIMENSION DIRECTIONA DIVIDER DOWN DRYER EXHAUST EAT IN KITCHEN ELECTRIC(AL) ELECTRIC HEATER ELECTRIC METER ELEVATOR ENAMEL PAINT EQUAL EQUIPMENT ESTABLISHED GRADE EXIT SIGN EXIT LIGHT EXPANSION EXPOSED CONCRETE EXPANSION JOINT EXTERIOR FIRE EXTINGUISHER FULL HEIGHT FIRE RATING FRESH AIR INTAKE
FACE BRICK
FULL FALSE BEAM DROP FINISH FLOOR ELEVATION FLUSH HOLLOW METAL FLUSH OPENING FIRE PROOF FACTORY PRIME COAT FROSTPROOF HOSE BIBB FIREPROOF SELF-CLOSING FIREPROOF WIRE GLASS FIRE STANDPIPE FURNITURE FITTINGS EQUIPM FINISH (ED) FINISH FLOOR FIXTURE

FLOOR DRAIN

FLASHING FOUNDATION

ABBREVIATIONS LIST

ABBREVIATIONS LIST GRAR HAR GYPSUM BOARD FURRED BEAM GYPSUM BOARD HUNG CEILING GYPSUM BOARD TRIMMED OPENING GALVANIZED GENERAL GLASS GRADE GARBAGE CHUTE GYPSUM WALLBOARD GYPSUM DRYWALL CONSTRUCTION HOSE BIB HUNG CEILING HOLLOW METAL HIGH POINT HAND RAIL HALL VENT (DUCT) HOT WATER INSIDE DIAMETER INSULATED GYPSUM BOARD CEILING INSULATION INTERIOR JANITOR CLOSET JOINT KITCHEN KITCHENETTE KITCHEN EXHAUST LOUVER DOOR LOOSE LINTEL ABOVE LOW POINT LAIMINATED LAMINATED PLASTIC LEADER LINEN CLOSET LIGHTWEIGHT MASTER BATHROOM MATERIAL & EQUIPMENT ACCEPTANCE DIV. METAL LINED METAL LOUVER VENT MASONRY OPENING MEN'S TOU FT MECHANICAL WATERPROOFING MAINTAIN, MAINTENANCE MASONRY

MARBLE SADDLE MASTER BEDROOM MB. SDL.
MBR.
MECH.
MET.
MIN.
MISC.
MSNRY.
MID.
N.G.
N.H.C.
N.I.C.
N.I.C.
N.I.C.
O.D.
O.F.
O.H.
O.T.B.
OPEN SH.
OPEN
OPN.
OPN.
COPN.
COPN. MECHANICAL METAL MINIMUM MISCELLANEOUS MASONRY MOUNTED NON-CORROSIVE NO HUNG CEILING NOT IN CONTRACT NOT TO SCALE NOMINAL ON CENTER OUTSIDE DIMENSION OVERFLOW OPPOSITE HAND OPEN TO BELOW OPEN SHELF/ SHELVES OPEN CABINET OPPOSITE PUMP DISCHARGE PUBLIC HALL PUBLIC CORRIDOR VENT DUCT PIECE PLANTER PLANTER BOX PLANTER DRAIN PLYWOOD DIVIDER POLISHED PRIMER SEALER POL
PR. SLR.
PR.MD. FIL
PT. PTD.
PWDR.
R.
R.D.
R.H.
R.W.
RAD.
REC.
REF.
RESIL
RM. PREMOLDED FILLED PAINTED POWDER ROOM ROOF DRAIN RANGE HOOD RETAINING WALL RADIATOR, RADIUS RECESSED REFRIGERATOR RESILIENT RECESSED HAMPER ROOM SMOKE ACTIVATED DOOR SIMILI ATED ACCOUSTICAL PAINT SPRAY ON PAINT

S.V.
SEP.
SH.V.
SEP.
SH.V.
SN.RD.
SS.S.D.
SPRIK.
ST.STL.
ST.STL.
ST.ST.
ST.ST. SINGLE ROD SLIDING SHOWER DOORS SPRINKLER STAINLESS STEEL STATIONARY STEEL SADDLE STORAGE STRUCTURAL JOINTS SURFACE MOUNTED SERVICE CLOSET SERVICE ELEVATOR TOP OF COPING TOP FLOOR ONLY TRIMMED OPENING TOP OF CURB TOP OF SLAB TOP OF WALL TOP REGISTER TEMPERED TEXTURED ACOUSTIC PAINT TERRAZZO SADDLE TELEVISION TOWEL BAR TOILET EXHAUST UNLESS OTHERWISE NOTED VINYL COVE BASE VINYL CONTROL JOINT VINYL COMPOSITE TILE VINYL STRAIGHT BASE VINYL TILE VINYL WALL FABRIC VENTILATION VESTIBULE VERIFY IN FIELD VISION PANEL WATER CLOSET WEEP HOLE WROUGHT IRON WALK IN CLOSET WATERPROOF WATER RESISTANT GYPSUM BOARD WEATHER STRIPPING

WOMEN'S TOILET

ABBREVIATIONS LIST

SERVICE VENT (DUCT)

SHEAR WALL

SHELF, SHELVES

SEPARATE

ABBREVIATIONS LIST

W/ W/D W/O W/D WHRL WHRL AP. WND DIM WL CAB. WM. WR GL WIR RES.

WITH WASHER / DRYER WITHOUT

WHIRLPOOL ACCESS PANE

WINDOW DIMENSION

WALL CABINET WASHING MACHINE

WATER RESISTANT

WIRE GLASS

WOOD

RECEIVED

VILLAGE OF GREENPORT **BUILDING DEPARTMENT** 

AUG 0 2 2022

Tax May # 1001-2-226 Existing

AREA OF HOUSE + DECK = 1,120 sf

LOT AREA =

E 9

5,040 SF

LOT COVERAGE =

22.2%

Proposed design

AREA OF HOUSE AND DECK = 1,508 SF


LOT AREA

5,040 SF

LOT COVERAGE

29.9%

OPERTY OF JOHN A. MONSELL

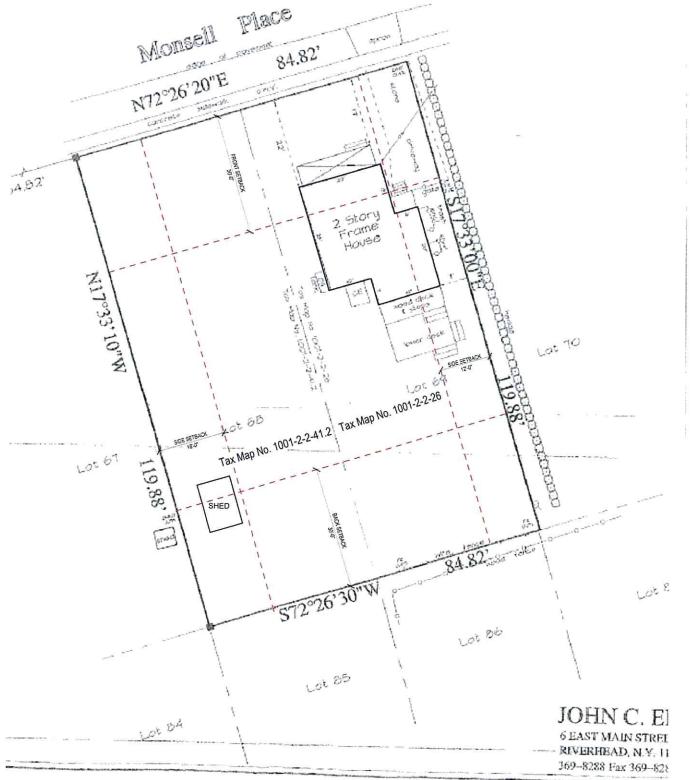

225 MONSELL PLACE

ISSUE/REVISION DATE 2 Rev 2 04/06/22

CONSULTANTS

THE TURETT COLLABORATIVE 277 BROADWAY, SUITE 1300 NEW YORK, NY, 10007 212.965.1244

STRUCTURAL ENGINEER

XXXX XXXX XXXX

MECHANICAL ENGINEER

XXXX XXXX XXXX

AV+IT CONSULTANT

XXXX XXXX XXXX

ACOUSTICAL CONSULTANT

XXXX XXXX XXXX

CONSULTANT 6 TYPE

XXXX XXXX

CONSULTANT 7 TYPE

XXXX XXXX XXXX XXXX

THE TURETT COLLABORATIVE:

277 380ADWAY STUDIO 1300 | NEW YORK, NY 10001 1: 212.955 1244 | E: INFOSTURETTARCH.COM


DRAWING TITLE

**EXISTING SURVEY** 

STAMP & SIGNATURE PROJ. NO.: 2018 03/17/21 SCALE:

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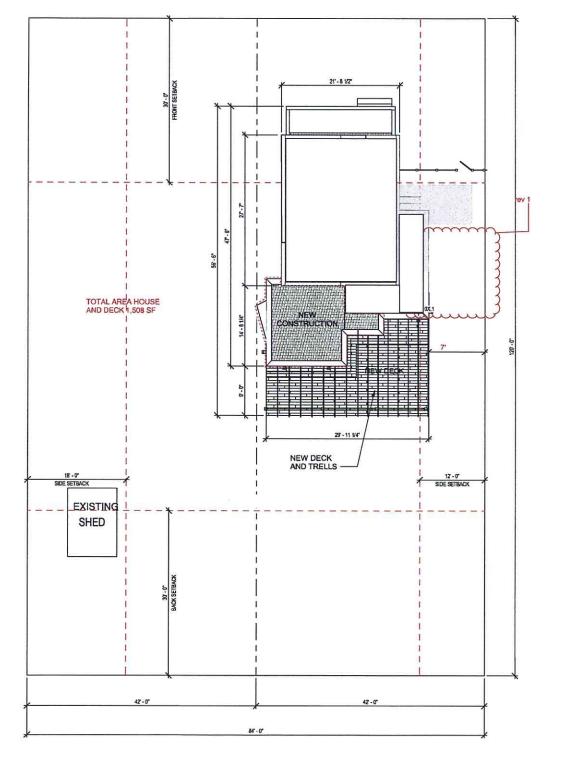


Existing First Floor = 874 SF Proposed First Floor = 1,110 SF

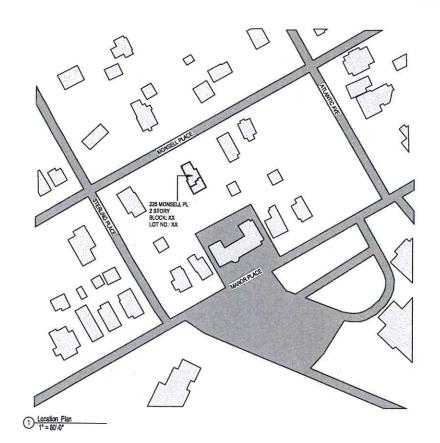Existing Second Floor = 599 SF Proposed Second Floor = 599 SF

Existing Deck = 246 SF Proposed Deck = 398 SF

BULK REQ. DISTRICT R-1 MINIMUM REQUIREMENTS FOR 1-FAMILY DETACHED ... LOT SIZE (SQUARE FEET) 10,000 80 100 LOT WIDTH (FEET) LOT DEPTH (FEET) FRONT YARD (FEET) 30 SIDE YARD (FEET) BOTH SIDE YARDS (FEET 12 REAR YARD (FEET) 30 LIVABLE FLOOR AREA (SQUARE FEET PER DWELLING UNIT) 1,000 MAXIMUM PERMITTED DIMENSIONS: LOT COVERAGE (PERCENT) 30% BUILDING HEIGHT (FEET) 35 NUMBER OF STORIES 2





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VILLAGE OF GREENPORT BUILDING DEPARTMENT

225 MONSELL PLACE

ISSUE/REVISION

1. deleted Bilco Dr

DATE 033022

CONSULTANTS

ARCHITECT

THE TURETT COLLABORATIVE 277 BROADWAY, SUITE 1300 NEW YORK, NY, 10007 212.965.1244

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CONSULTANT 7 TYPE

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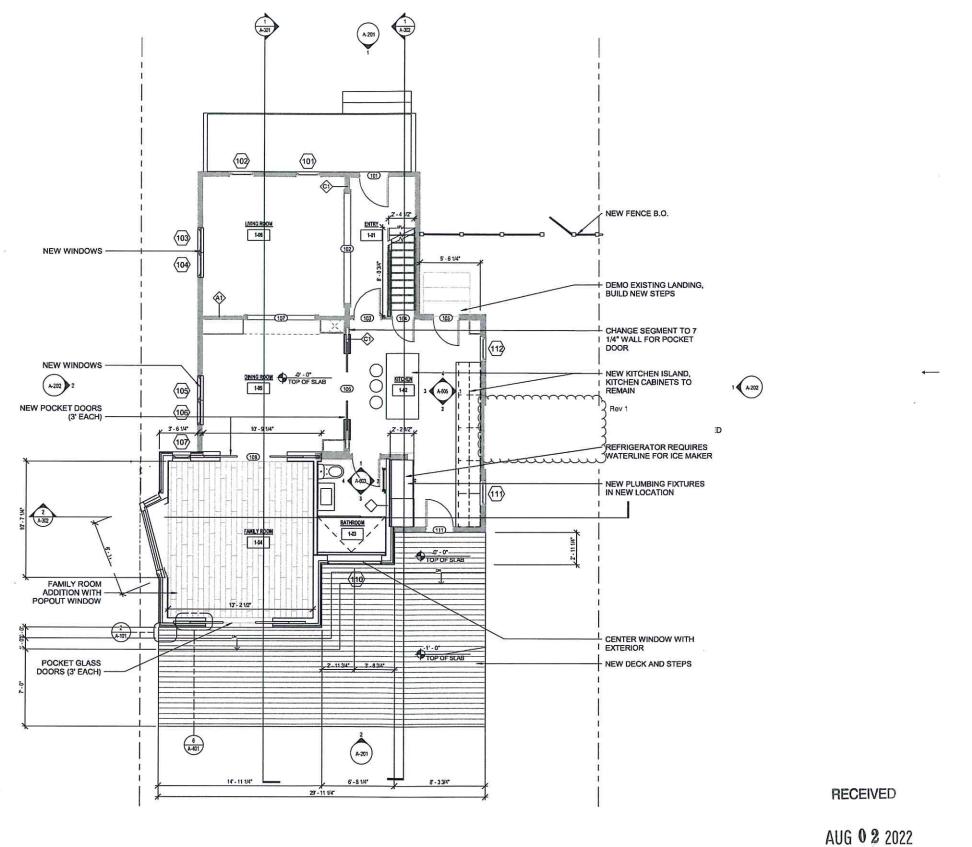
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NEW PROPOSED SITE PLAN

STAMP & SIGNATURE PROJ. NO.: 2018 SCALE: As indicated



ISSUE/REVISION DATE
Rev 1 - delete Bilco door 033022
Rev 2 -revised baywindow to be on one lot. 060122

CONSULTANTS

ARCHITECT
THE TURETT COLLABORATIVE
277 BROADWAY, SUITE 1300
NEW YORK, NY, 10007
212.965.1244

STRUCTURAL ENGINEER

XXXX

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XXXX

XXXX

MECHANICAL ENGINEER

XXXX XXXX XXXX

AV+IT CONSULTANT

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ACOUSTICAL CONSULTANT

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CONSULTANT 6 TYPE

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CONSULTANT 7 TYPE

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THE TURETT COLLABORATIVE:


ITT BROADWAY STUDIO 1900 NEW YORK, NY 100 T: 212,965 1244 - E: INFO#TUBETTARCH.CO

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VILLAGE OF GREENPORT

BUILDING DEPARTMENT


CONSTRUCTION PLAN -LEVEL 1

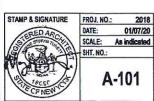

CONSTRUCTION PLAN - LEVEL 1
1/4" = 1'-0"

2 PLAN DETAIL - WOOD DECK 1 1/2" = 1'-0"

 $\bigcirc$ 

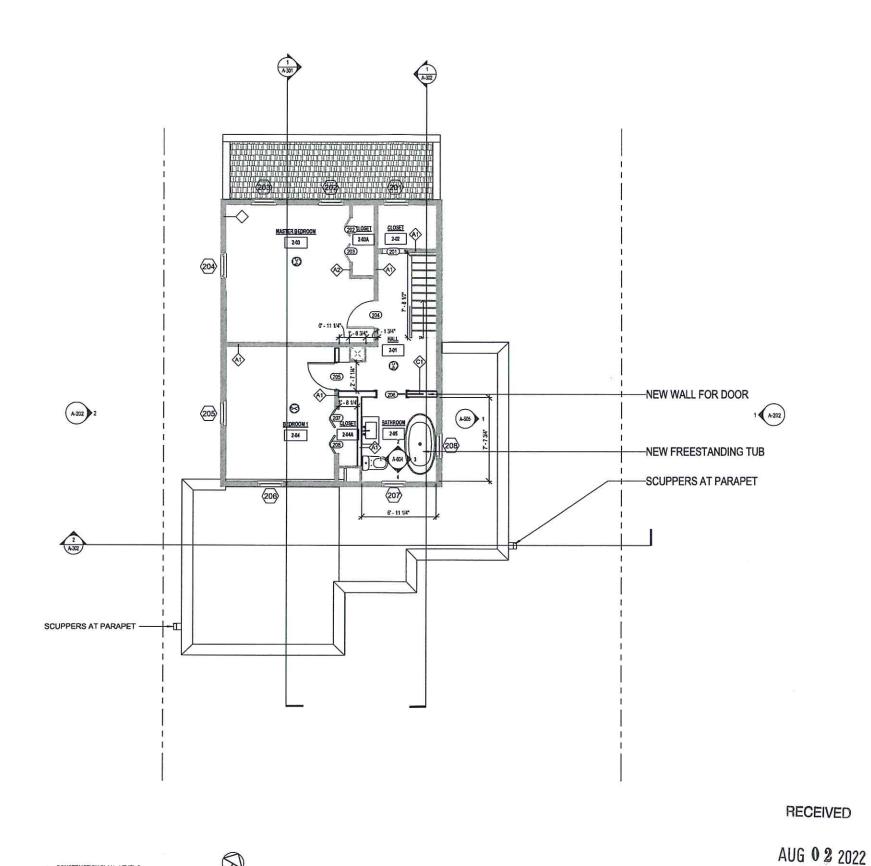

ONSTRUCTION PLAN - LEVEL 2

225 MONSELL PLACE

DATE ISSUE/REVISION

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ARCHITECT

THE TURETT COLLABORATIVE 277 BROADWAY, SUITE 1300 NEW YORK, NY, 10007 212 965 1244

STRUCTURAL ENGINEER

XXXX XXXX XXXX

MECHANICAL ENGINEER

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ACOUSTICAL CONSULTANT

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CONSULTANT 6 TYPE

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CONSULTANT 7 TYPE

XXXX XXXX XXXX

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CONSTRUCTION PLAN -LEVEL 2

 $\bigoplus^{N}$ 

VILLAGE OF GREENPORT BUILDING DEPARTMENT

ISSUE/REVISION A 302 CONSULTANTS THE TURETT COLLABORATIVE 277 BROADWAY, SUITE 1300 NEW YORK, NY, 10007 212 985.1244 STRUCTURAL ENGINEER XXXX XXXX XXXX MECHANICAL ENGINEER XXXX XXXX XXXX A-202 2 -NEW PARAPET AROUND 1 STORY SECTION AV + IT CONSULTANT XXXX XXXX XXXX -EXISTING ROOF TO REMAIN ACOUSTICAL CONSULTANT XXXX XXXX XXXX -NEW DOWNSPOUT + LEADER CONSULTANT 6 TYPE XXXX XXXX XXXX CONSULTANT 7 TYPE XXXX NEW DOWNSPOUT + LEADER-NEW ROOF TO CONNECT WITH EXISTING-DRAWING TITLE DRAIN ROOFS TO LEADERS + GUTTERS RECEIVED 1/4" = 1'-0" AUG 0 2 2022

225 MONSELL PLACE


DATE


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CONSTRUCTION PLAN - ROOF

STAMP & SIGNATURE PROJ. NO.: 2018 DATE: 01/07/20 SCALE: 1/4" = 1'-0"



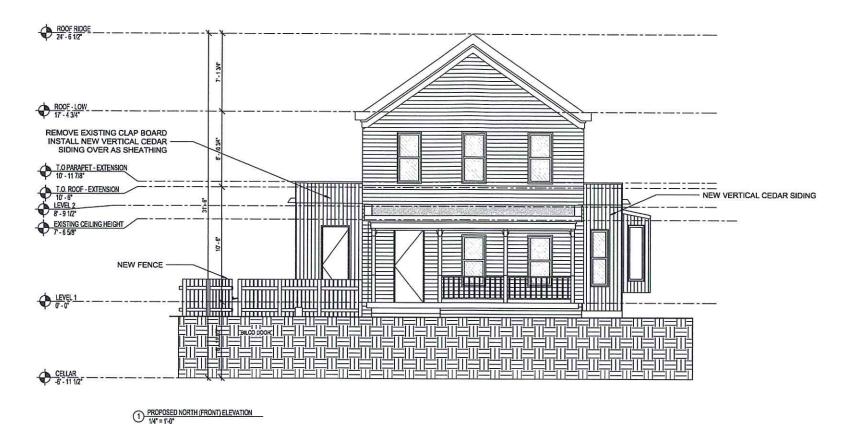

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STRUCTURAL ENGINEER

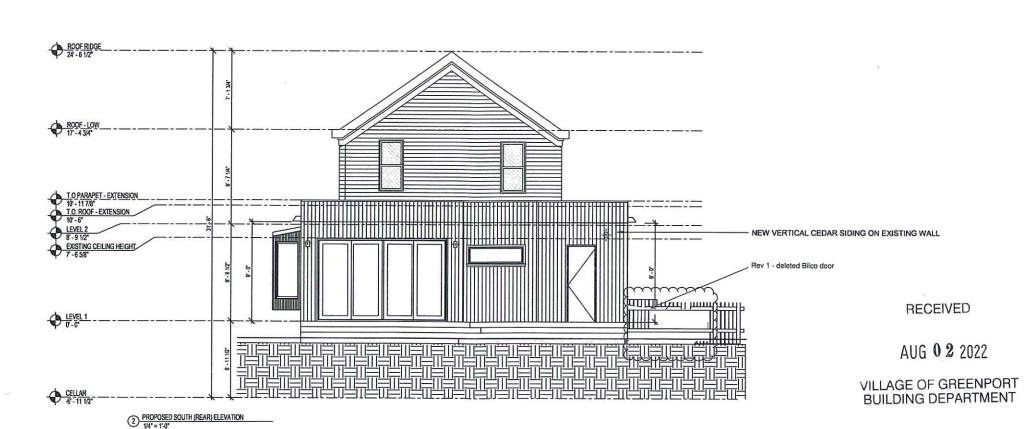XXXX XXXX XXXX

MECHANICAL ENGINEER

XXXX XXXX XXXX

AV + IT CONSULTANT

XXXX XXXX XXXX

ACOUSTICAL CONSULTANT

XXXX XXXX XXXX

CONSULTANT 6 TYPE

XXXX XXXX XXXX

CONSULTANT 7 TYPE

XXXX XXXX XXXX

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DRAWING TITLE

BUILDING ELEVATIONS -NORTH & SOUTH


STAMP & SIGNATURE PROJ. NO.: 2018

DATE: 09/23/19


SCALE: 1/4" = 1"-0"

SHT. NO.: 5 of 85

A-201

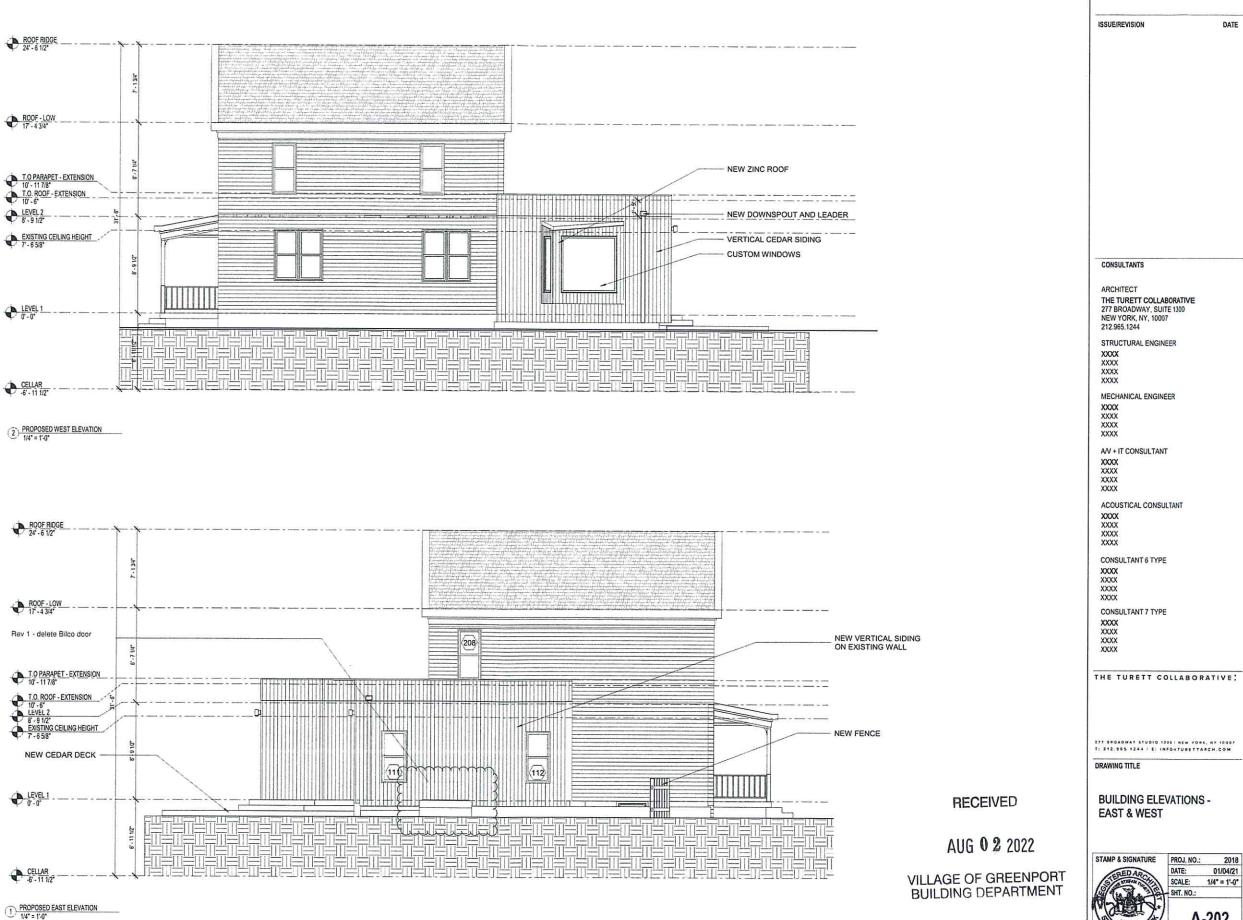

A-202

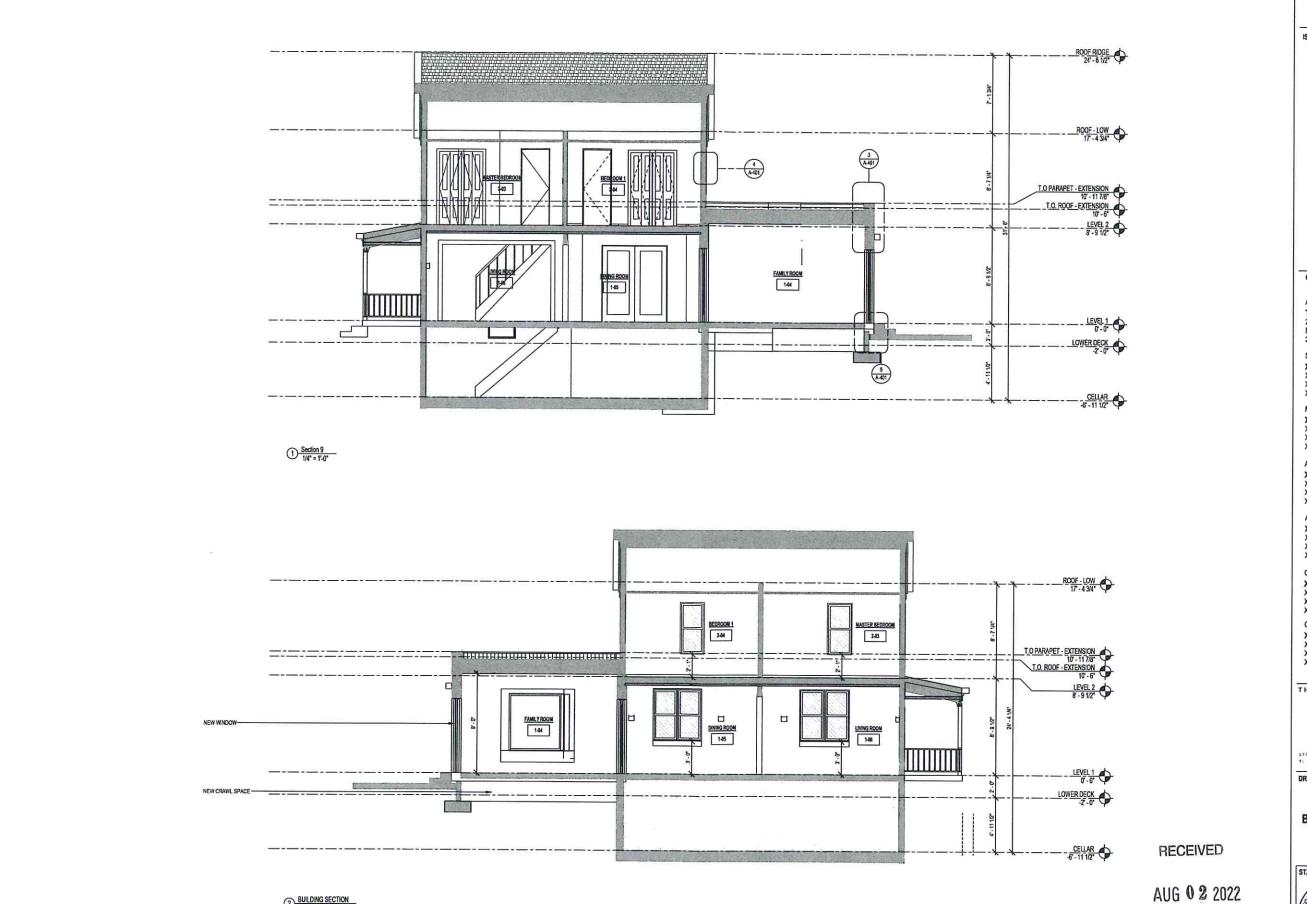

2 BUILDING SECTION

1/4" = 1'-0"

225 MONSELL PLACE

ISSUE/REVISION

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THE TURETT COLLABORATIVE
277 BROADWAY, SUITE 1300
NEW YORK, NY, 10007
212.965.1244

STRUCTURAL ENGINEER

XXXX XXXX XXXX

MECHANICAL ENGINEER

XXXX XXXX XXXX

AV + IT CONSULTANT

XXXX XXXX XXXX

ACOUSTICAL CONSULTANT

XXXX XXXX XXXX

CONSULTANT 6 TYPE

XXXX XXXX XXXX

CONSULTANT 7 TYPE

XXXX XXXX XXXX

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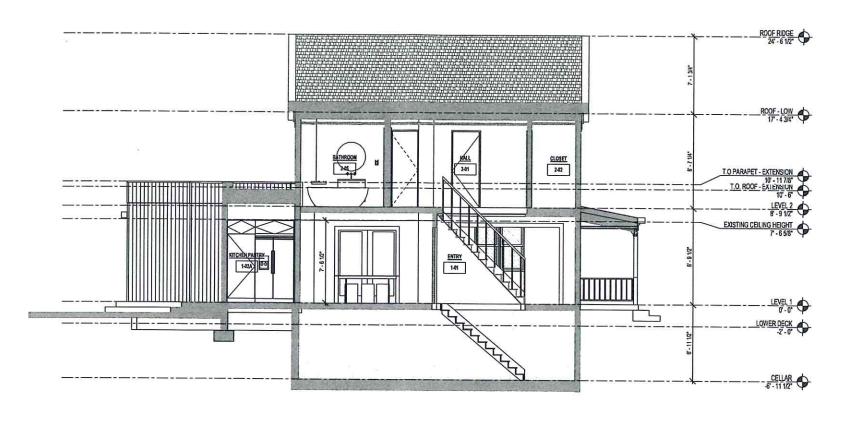
VILLAGE OF GREENPORT BUILDING DEPARTMENT

**BUILDING SECTION** 


PROJ. NO.: 2018

DATE: 01/04/21

SCALE: 1/4" = 1'-0"



1/4" = 1'-0"

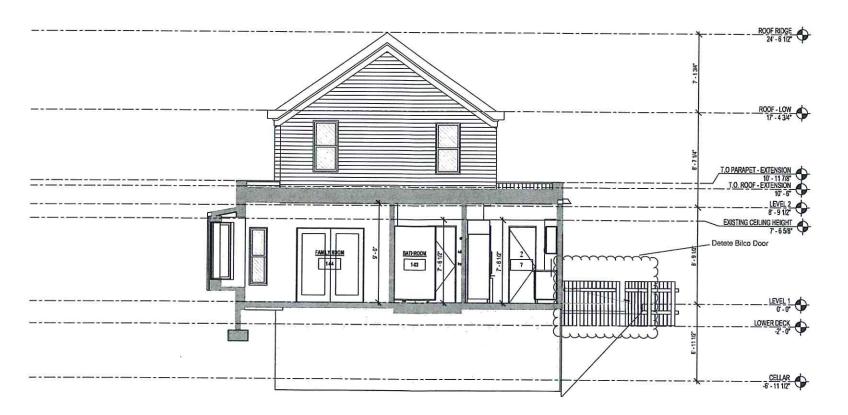

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VILLAGE OF GREENPORT BUILDING DEPARTMENT

225 MONSELL PLACE

ISSUE/REVISION

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STRUCTURAL ENGINEER

XXXX XXXX XXXX

MECHANICAL ENGINEER

XXXX XXXX XXXX

AV+IT CONSULTANT

XXXX XXXX XXXX

ACOUSTICAL CONSULTANT

XXXX XXXX XXXX

CONSULTANT 6 TYPE

XXXX XXXX XXXX

CONSULTANT 7 TYPE


XXXX XXXX XXXX

THE TURETT COLLABORATIVE:


07/20/21

DRAWING TITLE

BUILDING SECTION B

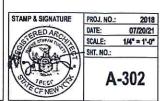


2 Section 8 1/4" = 1"-0"

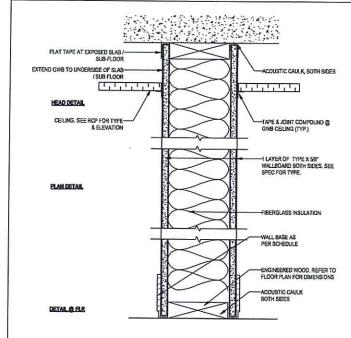

PARTITION TYPE	STUD SIZE	OVERALL DIMENSION	STC RATING	UL DEBIGN NO
A1	2X4	SEE PLANS		
A2	2 X 6	SEE PLANS		

<sup>\*</sup> PROVIDE CEMENT BOARD AT WET AREA, TYP.

1 PARTITION TYPE A NON-RATED2
3\* = 1'-0\*

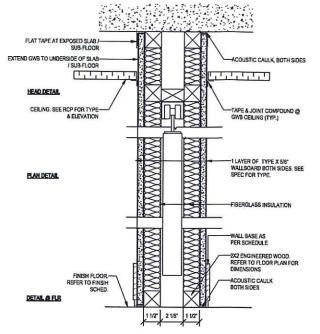

PARTITION TYPE	STUD SIZE	OVERALL DIMENSION	STC RATING	UL DESIGN NO.
C1	202	SEE PLANS		
				<u> </u>

2 PARTITION TYPE C - NON-RATED POCKET DOOR
3" = 1'-0"

225 MONSELL PLACE

ISSUE/REVISION

08/04/2021

DATE

CONSULTANTS

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212 965.1244

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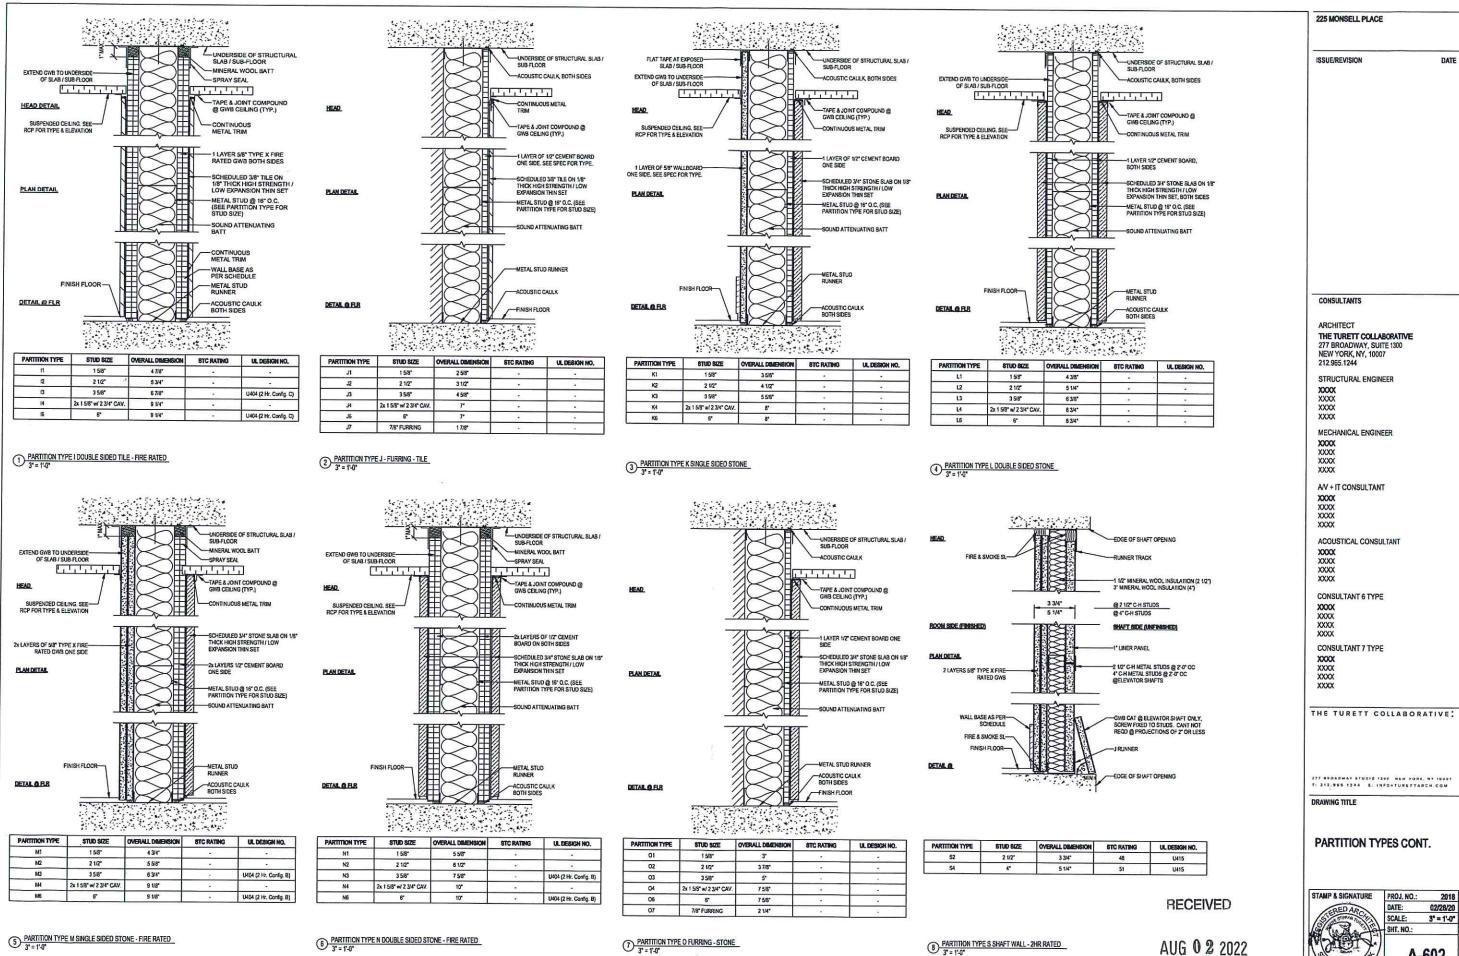
PARTITION TYPES

AUG 0 2 2022

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NATURE	PROJ. NO.:	2018
AR	DATE:	04/15/2021
128/201	SCALE:	3" = 1'-0"
2	SHT. NO.:	
	A	-601



VILLAGE OF GREENPORT BUILDING DEPARTMENT A-602

DATE

	200		DOOR SCHED	WE .
101	2.5	6.8	0-138	EXISTING TO REMAIN
102	10'-0"	7.0	0-13/4	
103	2-51/2	6.8	0'-13/5"	
104	2.0	6.8	0-138	
105	2-4	6-8	0-138	
106	5 - 4"	6-3	0'-11/2"	
107	6-1	7-0	0-13/4	
108	6'-0"	6'-8"	0'-11/2"	
111	2 - 5"	7.0	0'-13/8"	
111	2.5	7.0	0'-13/8"	
112	2.0	6.8	0'-13'8"	
201	2.0	6-8	0-13/4	EXISTING TO REMAIN
202	2.0	6.8	0-11/2	EXISTING TO REMAIN
203	2.0	6 - 8	0-11/2	EXISTING TO REMAIN
204	2.5	7-0	0-13/8	EXISTING TO REMAIN
205	2 - 5 1/2"	68.	0-13/8	EXISTING TO REMAIN
205	2 - 5 1/2"	6-8	0-138	EXISTING TO REMAIN
206	Z - 10°	7-0	0'-13/4"	
207	2.0	6.8	0-11/2	EXISTING TO REMAIN
208	2.0	6-8	0-11/2	EXISTING TO REMAIN
209	7.5	7-0	0'-13/8"	- Common Concession
210	6.0	6-8	0'-11/2"	

		WINDOW SCH	EDULE
101	4' - 8 1/4"	2-3	EXISTING TO REMAIN
102	4'-81/4"	2.3	EXISTING TO REMAIN
103	4" - 8 1/4"	2.3	
103	4" - 8 1/4"	2-3	
104	4" - 8 1/4"	2-3	
104	4'-81/4"	2.3	
105	4'-81/4"	2-3	
105	4'-81/4"	2-3	
106	4'-81/4"	2 - 3"	
106	4'-81/4"	2 - 3*	
107	5-3"	1'-8"	
108	5-2	1'-8"	
109	4'-91/2"	2.0	
110	1'-6"	5'-0"	
111	4'-81/4"	2 - 3"	
112	4'-8 1/4"	2 - 3*	
114	1-4	2-5	
115	4' - 8 1/4"	2-3	
201	4'-81/4'	2 - 3"	EXISTING TO REMAIN
202	4'-81/4"	2 - 3*	EXISTING TO REMAIN
203	4' - 8 1/4"	2 - 3	EXISTING TO REMAIN
204	4' - 8 1/4"	2.3	EXISTING TO REMAIN
205	4' - 8 1/4"	2.3	EXISTING TO REMAIN
206	4'-8 1/4"	2.3	EXISTING TO REMAIN
207	4'-8 1/4"	2 - 3"	EXISTING TO REMAIN
208	4'-81/4"	2.3	
209	4'-8 1/4"	2.3	

Finish Schedule						
Number	Name	Level	Base Finish	Wall Finish	Trim	Cellin
1-01	ENTRY	ILEVEL 1				100
1-02	KITCHEN	LEVEL 1				-
1-02	KITCHEN	LEVEL 1				-
1-02A	KITCHEN PANTRY	LEVEL 1				
1-03	BATHROOM	LEVEL 1	WOOD PTD TO MATCH	SAME AS EX'G PTD	PTD SAME AS EXIG	PTD
1-04	FAMILY ROOM	LEVEL 1	WOOD PTD TO MATCH EX'G	SHOWER TILE T-1 DRY WALL PTD	PTD SAME AS EXIG	PTD
1-05	DINING ROOM	LEVEL 1				1
1-06	LIVING ROOM	LEVEL 1				
2-01	HALL	LEVEL 2				
2-02	CLOSET	LEVEL 2				1
2-03	MASTER BEDROOM	LEVEL 2				
2-03A	CLOSET	LEVEL 2				
2-04	BEDROOM 1	LEVEL 2				
2-04A	CLOSET	LEVEL 2				
2-05	BATHROOM	LEVEL 2	WOOD PTD TO MATCH EXG	WOOD WAINSCOT PTD		PTD

ISSUE/REVISION

DATE

#### CONSULTANTS

ARCHITECT THE TURETT COLLABORATIVE 277 BROADWAY, SUITE 1300 NEW YORK, NY, 10007 212.965.1244

STRUCTURAL ENGINEER
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XXXX XXXX XXXX XXXX

MECHANICAL ENGINEER

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AV + IT CONSULTANT
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ACOUSTICAL CONSULTANT

XXXX XXXX XXXX XXXX

CONSULTANT 6 TYPE

XXXX XXXX XXXX XXXX

CONSULTANT 7 TYPE

XXXX XXXX XXXX XXXX

THE TURETT COLLABORATIVE:

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DOOR AND WINDOW SCHEDULE

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\frac{1}{2}	A-	701
	SHT. NO.:	
18	SCALE:	
1	DATE:	02/27/2
TURE	PROJ. NO.:	201