

MISC. GENERAL NOTES

- THIS PROJECT IS CONSTRUCTION OF ADDITION TO A METAL CANOPY STRUCTURE TO CONTINUE TO BE USED AS AN OPEN AIR BAR (OCCUPANCY A-2)
- THE HEIGHT OF THE NEW BUILDING WILL BE WILL MATCH THE EXISTING CANOPY STRUCTURE.
- THE FLOOR AREA COVERED BY THE NEW CANOPY IS 1, 158 SQ.FT. THE PROPOSED CONSTRUCTION IS STEEL STRUCTURE WITH FIRE-RETARDANT FABRIC ROOF AND WALLS.
- ALL WORK SHALL CONFORM TO THE REQUIREMENTS OF THE 2020 4. BUILDING CODE OF N.Y.S., ELECTRICAL CODE OF N.Y.S., FIRE CODE OF N.Y.S., EXISTING BUILDING CODE OF N.Y.S. AND
- THE MECHANICAL CODE OF N.Y.S. AND ASCE7. 5. DESIGN LOAD CALCULATION ARE BASED ON:

LIVE LOAD: 60 PSF AS PER TABLE I 607.1, BUILDING CODE OF NEW YORK STATE.
DEAD LOAD: AS EXISTING.

	DIGN CATAGORY B. AND EXPOSURE CA	ATAGORY "C", FOR 120 MPH 3 SECOND GUST.
LOCATION	LIVE	DEAD DEFLECT LIMIT
l st Fl. 2nd Fl.	100 PSF 100 PSF	2 PSF /360 2 PSF /360

- THE ARCHITECT ASSUMES NO RESPOSIBILITY FOR THE CONSTRUCTION MEANS, METHODS, TECHNIQUES, SEQUENCES, OR PROCEDURES, OR FOR SAFETY PRECAUTIONS AND PROGRAMS IN CONNECTION WITH THE WORK. THERE ARE NO WARRANTIES, NOR ANY MERCHANTIBILITY OF FITNESS FOR A SPECIFIC USE EXPRESSED OR IMPLIED IN THE USE OF THESE PLANS
- CONTRACTOR TO VERIFY ALL DIMENSIONS BEFORE STARTING CONSTRUCTION. DO NOT SCALE DRAWINGS. FOLLOW DIMENSIONS ONLY. CONTRACTOR(S) SHALL FURNISH AND INSTALL ALL MATERIAL AND EQUIPMENT SHOWN, LISTED, OR DESCRIBED ON THESE DRAWINGS SUBJECT TO QUALIFICATIONS, CONDITIONS, OR EXCEPTIONS AS NOTED. CONTRACTOR SHALL FURNISH ALL LABOR, SCAFFOLDING, AND TOOLS NECESSARY TO
- COMPLETE THE WORK.
- ALL MATERIAL SHALL BE INSTALLED IN STRICT CONFORMANCE WITH MANUFACTURER'S REQUIREMENTS AND SPECIFICATIONS.
- IO. CONTRACTOR SHALL OBTAIN ALL REQUIRED INSPECTIONS, APPROVALS AND CERTIFICATE OF OCCUPANCY.

DEMOLITION

- CONTRACTOR SHALL DEMOLISH PARTS OF EXISTING STRUCTURE AS INDICATED,
- AND REMOVE DEBRIS.
- CONTRACTOR SHALL DO ALL PATCHING REQUIRED DUE TO REMOVAL OF EXISTING WORK AND/OR INSTALLATION OF NEW WORK.
- ALL NEW WORK SHALL MATCH AND MEET FLUSH TO EXISTING WORK
- AS CLOSELY AS POSSIBLE UNLESS OTHERWISE NOTED. EXISTING STRUCTURE AND INTERIORS TO REMAIN SHALL BE PROTECTED 4
- AS NECESSARY DURING DEMOLITION AND CONSTRUCTION.
- CONTRACTOR SHALL PROTECT EXISTING SERVICES TO REMAIN AND SHALL NOTIFY ALL UTILITIES AND TELEPHONE SERVICES AND MAKE ARRANGEMENTS FOR HOOK-UP, REMOVAL, OR CAPPING OF EQUIPMENT AS NECESSARY.

FOUNDATIONS N/A

GENERAL CONSTRUCTION

- PROVIDE ALL LABOR, MATERIALS, TRANSPORTATION, EQUIPMENT AND SERVICES NECESSARY TO COMPLETE ALL WOOD AND PLASTIC WORK REQUIRED BY THE DRAWINGS AS SPECIFIED HEREIN, OR REASONABLY IMPLIED AS NECESSARY TO COMPLETE THE WORK.
- INTERIOR TRIM SHALL MATCH EXISTING.
- FRAMING ELEMENTS: A. ALL FRAMING LUMBER SHALL BE GRADE STAMPED DOUGLAS FIR-
- LARCH STRUCTURAL GRADE NO.2 OR BETTER. B. ALL HEADERS 6'-0" AND OVER SHALL BE SUPPORTED WITH DOUBLE
- UPRIGHTS, 9'-0" AND OVER WITH TRIPLE UPRIGHTS. ALL HEADERS SHALL BE A MIN. OF (2)2"x8" OR AS SHOWN ON DRAWING.
- C. ALL FLUSH WOOD CONNECTIONS SHALL BE FASTENED WITH RATED GALVANIZED METAL CONNECTORS BY "SIMPSON" OR APPROVED EQUAL.
 D. NAILING SCHEDULE SHALL BE AS PER N.Y.S. BUILDING CODE AS A MINIMUM. ALL 2"x6" STUDS SHALL RECEIVE 5 1 OA NAILS AT SILL AND PLATE. ALL EXTERIOR NAILS SHALL BE GALVANIZED.
- E. PLYWOOD SHEATHING TO BE NAILED 84 NAILS @ 4" O.C. EXTERIOR EDGES AND 64 NAILS @ I 2" O.C. INTERMEDIATE.
- F. ALL INTERIOR AND EXTERIOR FINISHES TO BE SELECTED BY OWNER. 4. LOAD PATHS ARE INDICATED BY SECTION DRAWINGS.
- NEW INTERIOR DOORS SHALL MATCH EXISTING.
- NEW HARDWARE SHALL MATCH EXISTING.
- GYPSUM BOARD SHALL BE EASED EDGE TYPE,
- CONFORMING TO ASTM C36, AND SHALL BE "SHEETROCK SW" BY U.S. GYPSUM CO. OR APPROVED EQUAL. GYPSUM WALLBOARD THICKNESS SHALL BE ALL NEW AND REPAIRED GYP. BOARD SHALL BE TAPED AND SPACKLED THREE (3) COATS. ALL EXTERIOR
- 8.

CORNERS SHALL HAVE METAL CORNER BEADS. FINISHES

- I. ALL FINISHES SHALL MATCH EXISTING.
- HVAC

I. N/A


PLUMBING


I. N/A

CLIMATIC AND GEOGRAPHIC CRITERIA
GROUND SNOW LOAD20 PSF(PER SEC. I 608 BCNYS)WIND SPEEDI 20 MPH(PER SEC. I 609 BCNYS)SEISMIC DESIGN CATAGORYB(PER SECT. R301.2(2) RCNYS)WINTER DESIGN TEMPI I°F(PER TABLE N I 101.2)FLOOD ZONE(N / A)(PER FEMA MAP)FROST LINE DEPTH36"
DESIGN LOAD CALCULATIONS (UNIFORM LIVE LOADS) ASSEMBLY/HOUSE OF WORSHIP GO PSI (PER TABLE 1 607.1 BCNYS)

ISSUES / REVISIONS

- ELECTRICAL
- I. FURNISH ALL LABOR, MATERIALS, EQUIPMENT, PLANT, FURNISH ALL LABOR, MATERIALS, EQUIPMENT, PLANT, TOOLS, AND SERVICES NECESSARY AND REQUIRED FOR PROPER AND COMPLETE INSTALLATION OF ALL NEW ELECTRICAL SYSTEMS AND RELATED WORK INDICATED, INCLUDING BUT NOT LIMITED TO: CONNECTIONS TO PREVIOUSLY INSTALLED ELECTRICAL SYSTEMS, WIRING, LIGHTING SERVICES, FEEDERS, DISTRIBUTION AND PROTECTION FOUR FAIL PROTECTION EQUIPMENT, CONNECTIONS TO APPLIANCES GROUNDING, AND ALL INCLUDING ALL CONNECTIONS AND DEVICES WITHIN THE SCOPE OF THE WORK AS SHOWN ON THE APPLICABLE DRAWINGS AND AS NORMALLY SPECIFIED IN THIS TYPE OF PROJECT AND INCLUDING CONNECTIONS TO PREVIOUSLY INSTALLED TRANSFORMERS AND ELECTRICAL DISTRIBUTION
- SYSTEMS. ALL WORK SHALL CONFORM TO THE REQUIREMENTS OF THE NATIONAL ELECTRICAL CODE 2020, NFPA NO, 70 LOCAL UTILITY STANDARDS, OCCUPATIONAL SAFETY AND HEALTH AGENCY (OSHA), THE NATIONAL ELECTRICAL MANUFACTURERS' ASSOCIATION (NEMA) AND ANY OTHER APPLICABLE CODES. IN THE EVENT OF CONFLICT, THE MORE STRINGENT REQUIREMENTS WILL APPLY.
- ALL PRODUCTS USED FOR ELECTRICAL WORK SHALL 3 BEAR THE UNDERWRITERS LABORATORIES, INC. LABEL AND BE SUITABLE FOR THE ENVIRONMENT IN WHICH THEY WILL BE INSTALLED.
- 4. ALL WORK ON THE ELECTRICAL SYSTEM SHALL BE PERFORMED BY OR UNDER THE SUPERVISION OF A
- PROPERLY LICENSED MASTER ELECTRICIAN. THE CONTRACTOR SHALL OBTAIN, SUBMIT, AND PAY FOR ALL PERMITS, LICENSES AND INSPECTIONS AS REQUIRED BY THE LOCAL, STATE, AND FEDERAL AUTHORITIES, AND ANY OTHER APPLICABLE JURISDICTION. CARBON MONOXIDE DETECTORS IN CONFORMANCE WITH 5. 6.
- APPLICABLE CODES SHALL BE CONNECTED TO THE LIGHTING CIRCUITS WITH NO INTERVENING WALL SWITCH. LINE CORD-CONNECTED, DIRECT PLUG-IN, AND BATTERY POWERED ALARMS ARE
- NOT ACCEPTABLE. ALARMS SHALL BE INSTALLED ON EACH LEVEL ON WHICH SLEEPING QUARTERS ARE LOCATED. SMOKE DETECTORS AND FIRE ALARMS SHALL BE PROVIDED IN ACCORDANCE WITH APPLICABLE CODES

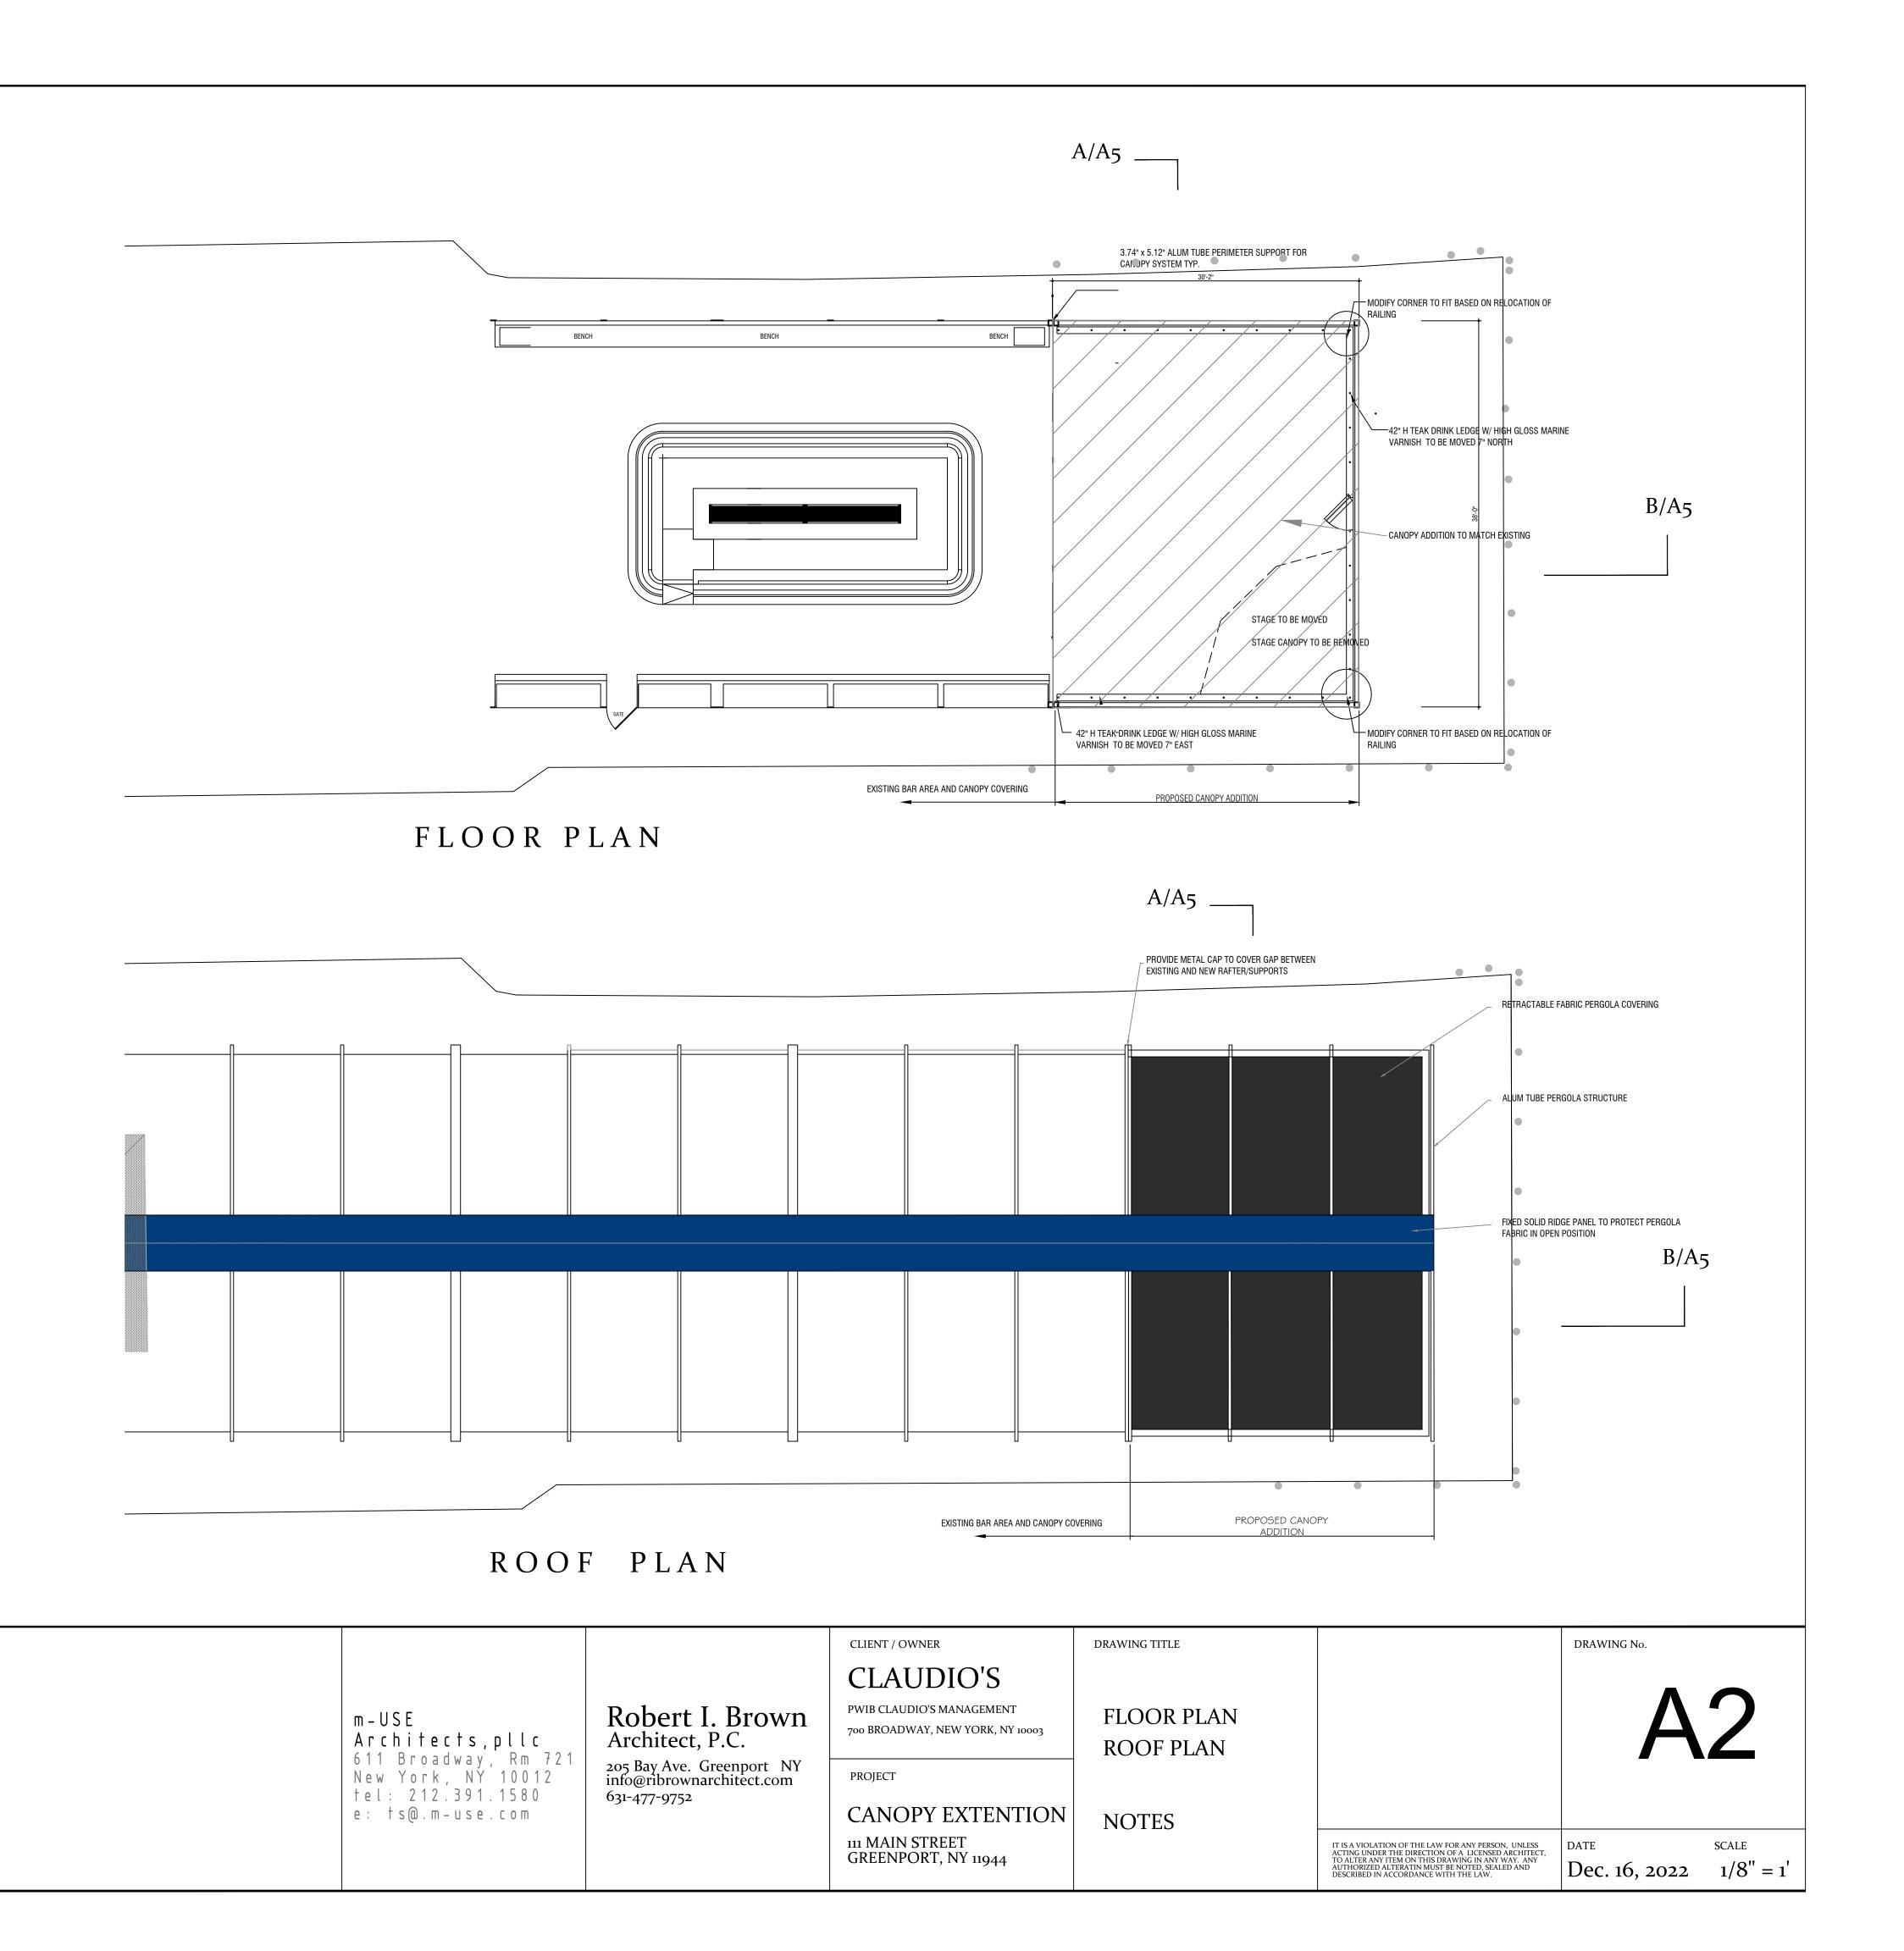

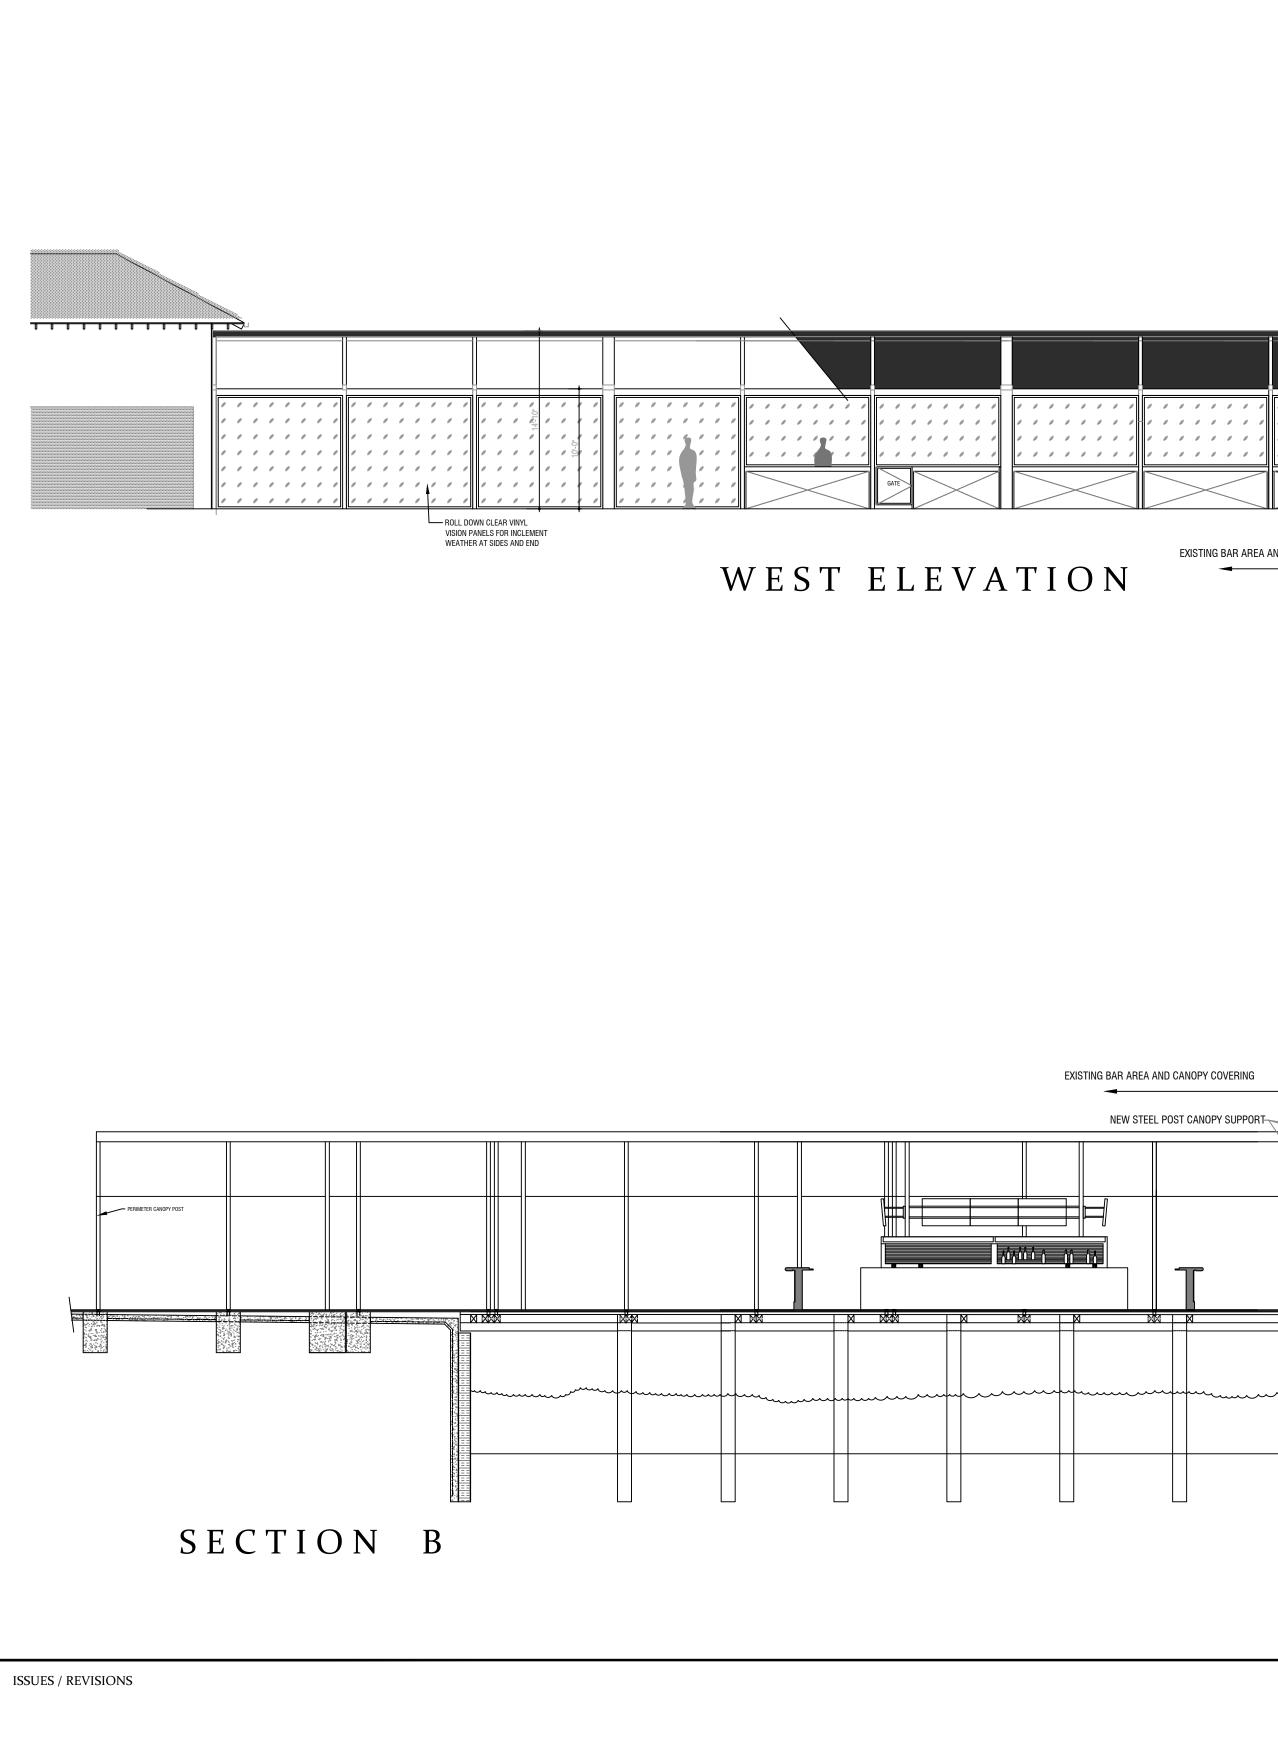

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PERIMETER CANOPY POST

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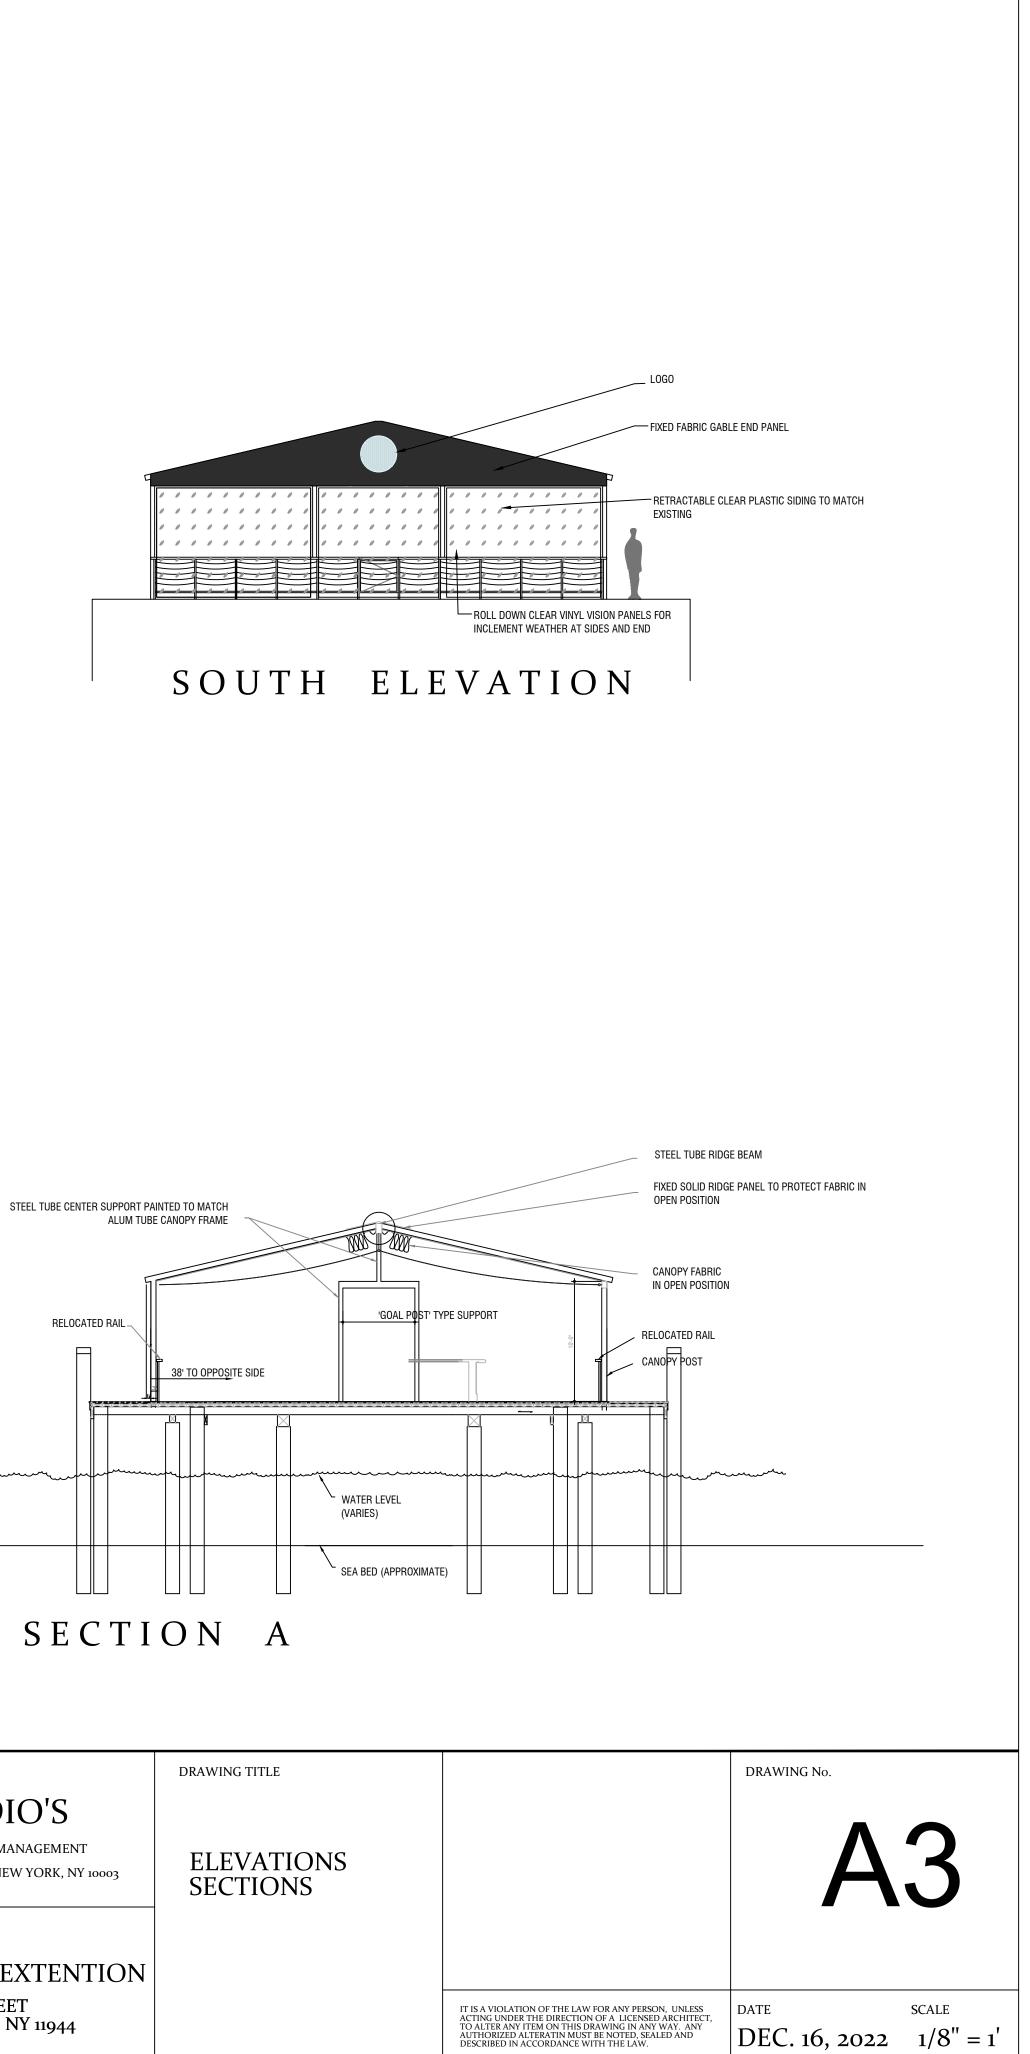
TEAK DRINK LEDGE W/ HIGH GLOSS MARINE VARNISH RELOCATED $-1\frac{1}{2}$ " Galvanized steel foot rail painted gloss WHITE ₽ PATUM ELEV. 0.0" EXISTING WOOD GIRDER AND SUBSTRUCTURE TO REMAIN OR BE PEPLACED 1¹/_{2"} DIA JUTE ROPE TYP RELOCATED 1 ¹/₂" GALVANIZED STEEL POSTS PAINTED GLOSS WHITE RELOCATED ∽ WATER LEVEL (VARIES) SEA BED (APPROXIMATE)


NEW ADDITION TO EXISTING

CANOPY, TO MATCH EXISTING


			RETRACTABLE FABRIC PERGOLA COVE
			ALUM TUBE PERGOLA STRUCTURE
• •	0 0	1 1	
_	EXISTING BAR AREA AND CANOPY COVERING	PROPOSED CANOPY ADDITION	

PERGOLA COVERING



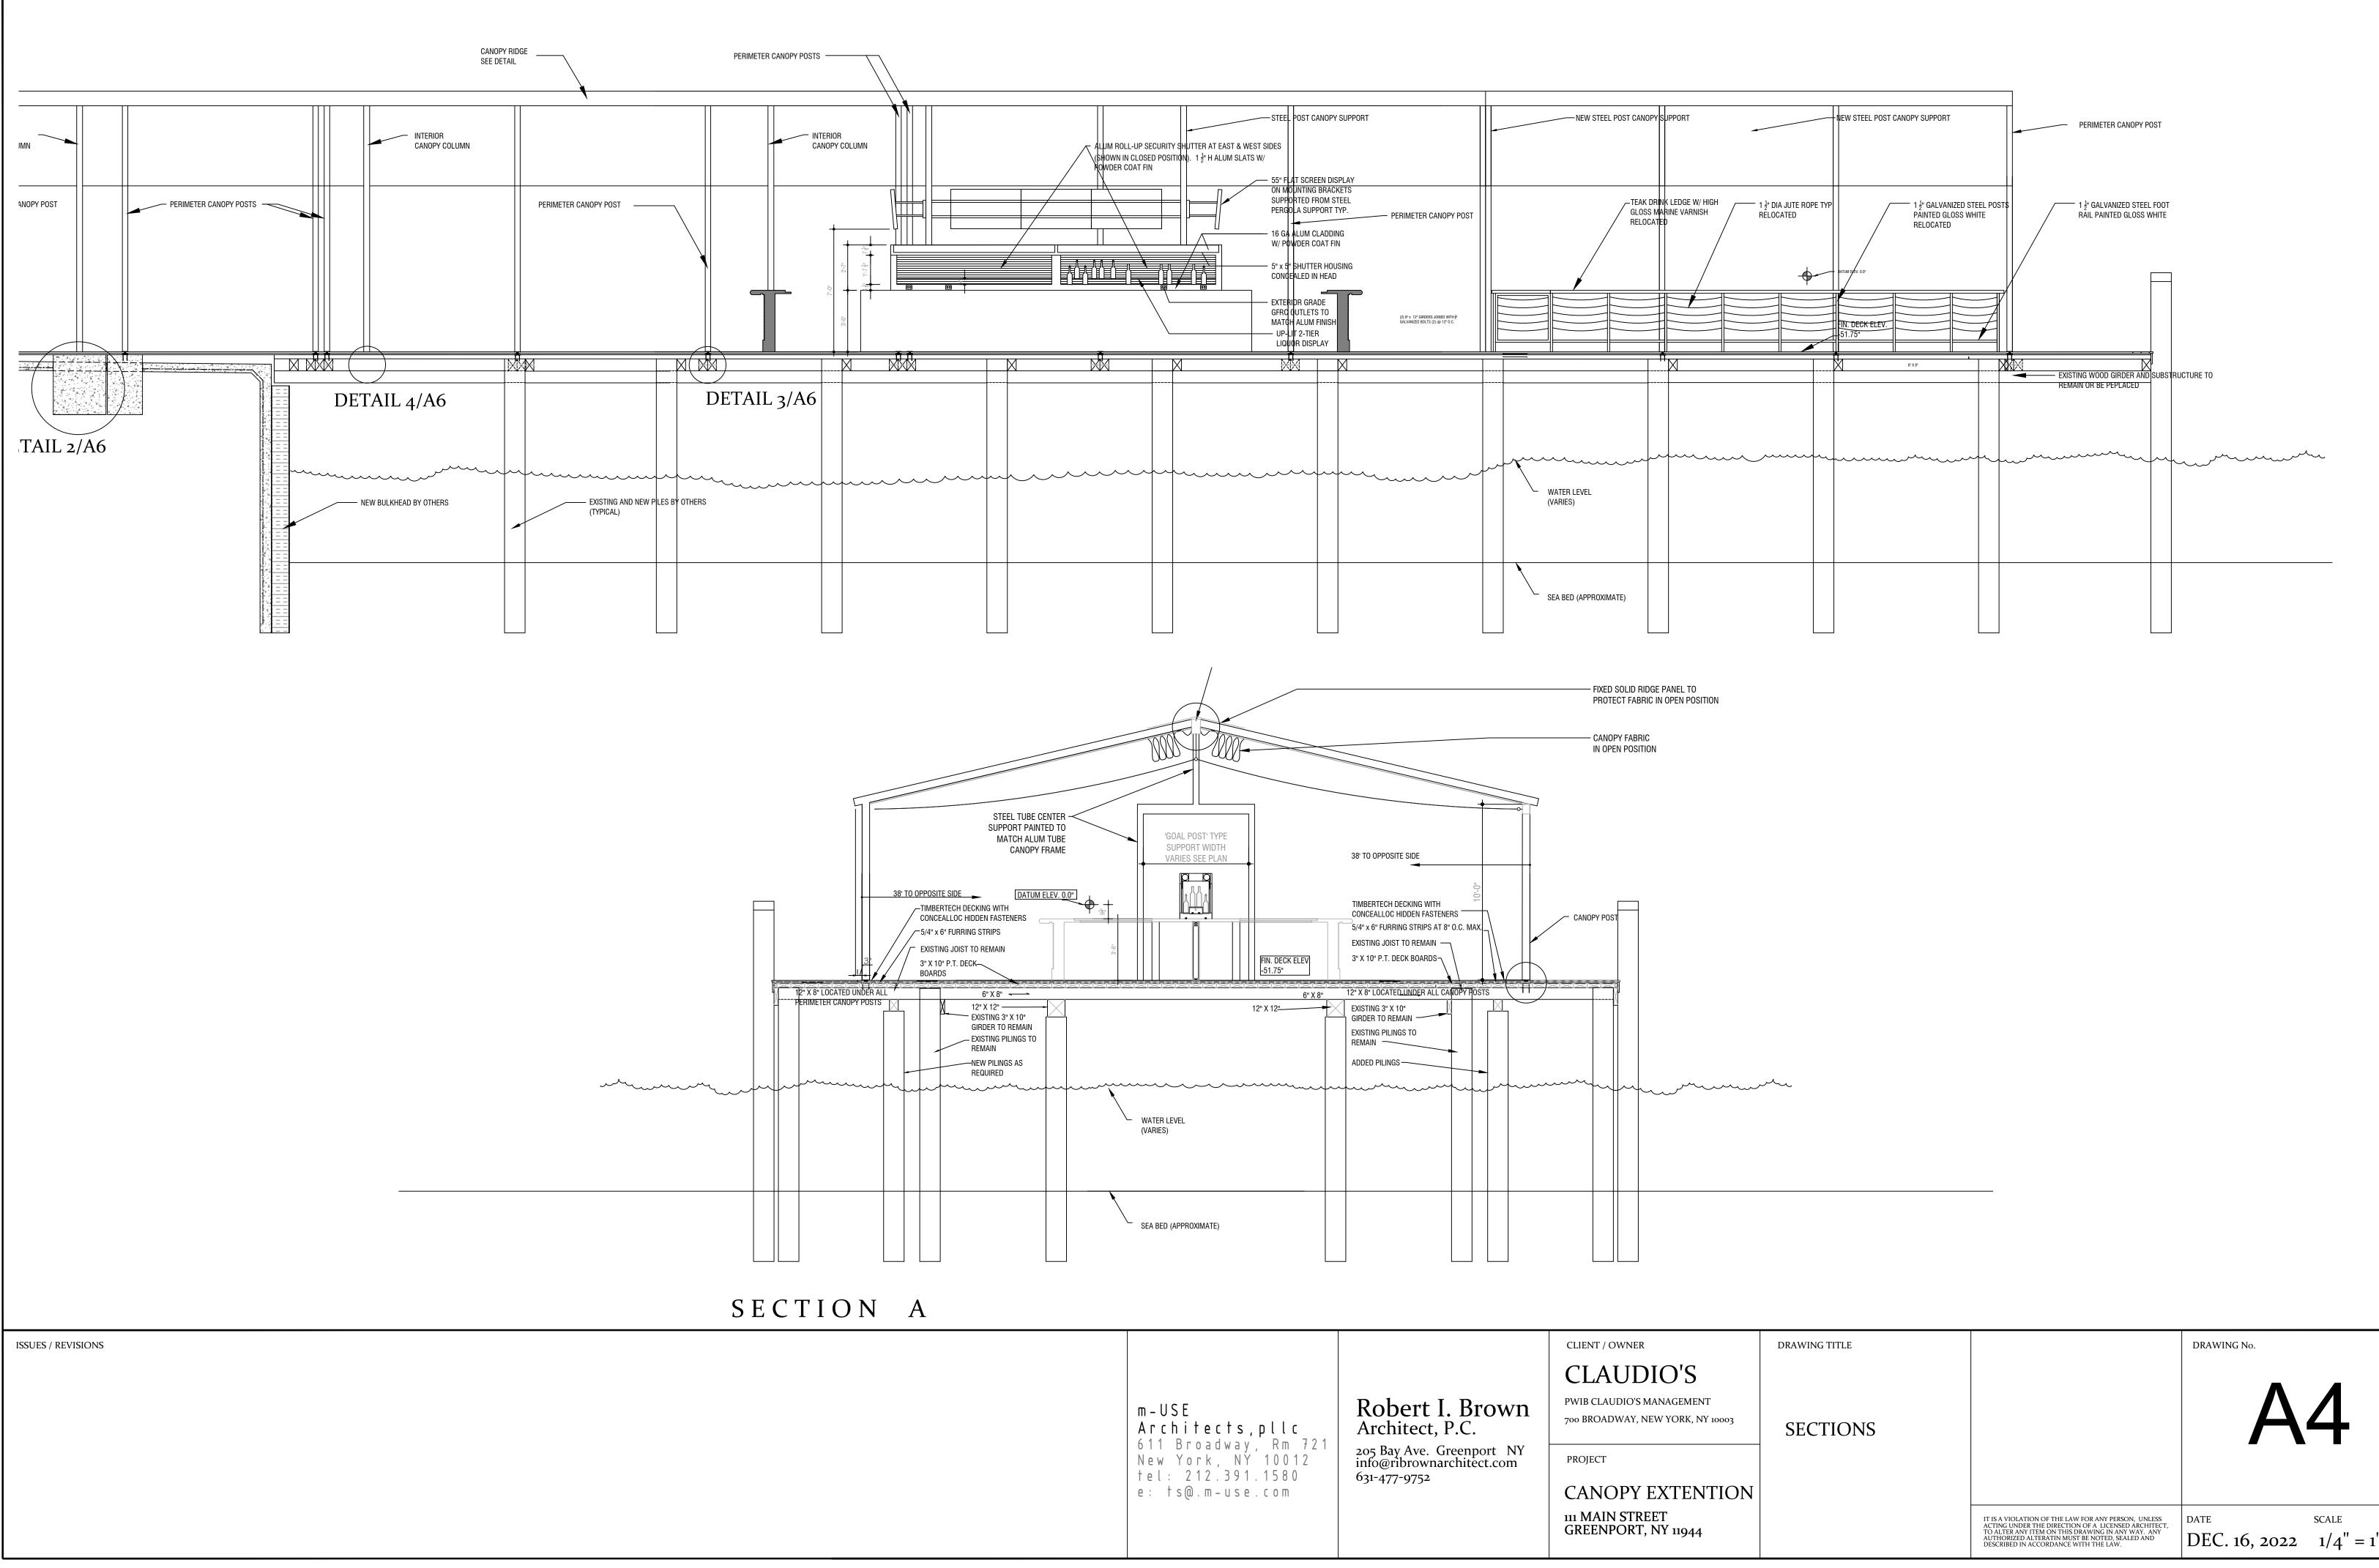

	DRAWING TITLE		DRAWING No.
NT NY 10003	SECTIONS		A4
JTION			
ŀ		IT IS A VIOLATION OF THE LAW FOR ANY PERSON, UNLESS ACTING UNDER THE DIRECTION OF A LICENSED ARCHITECT, TO ALTER ANY ITEM ON THIS DRAWING IN ANY WAY. ANY AUTHORIZED ALTERATIN MUST BE NOTED, SEALED AND DESCRIBED IN ACCORDANCE WITH THE LAW.	DATE SCALE $DEC. 16, 2022 1/4'' = 1'$

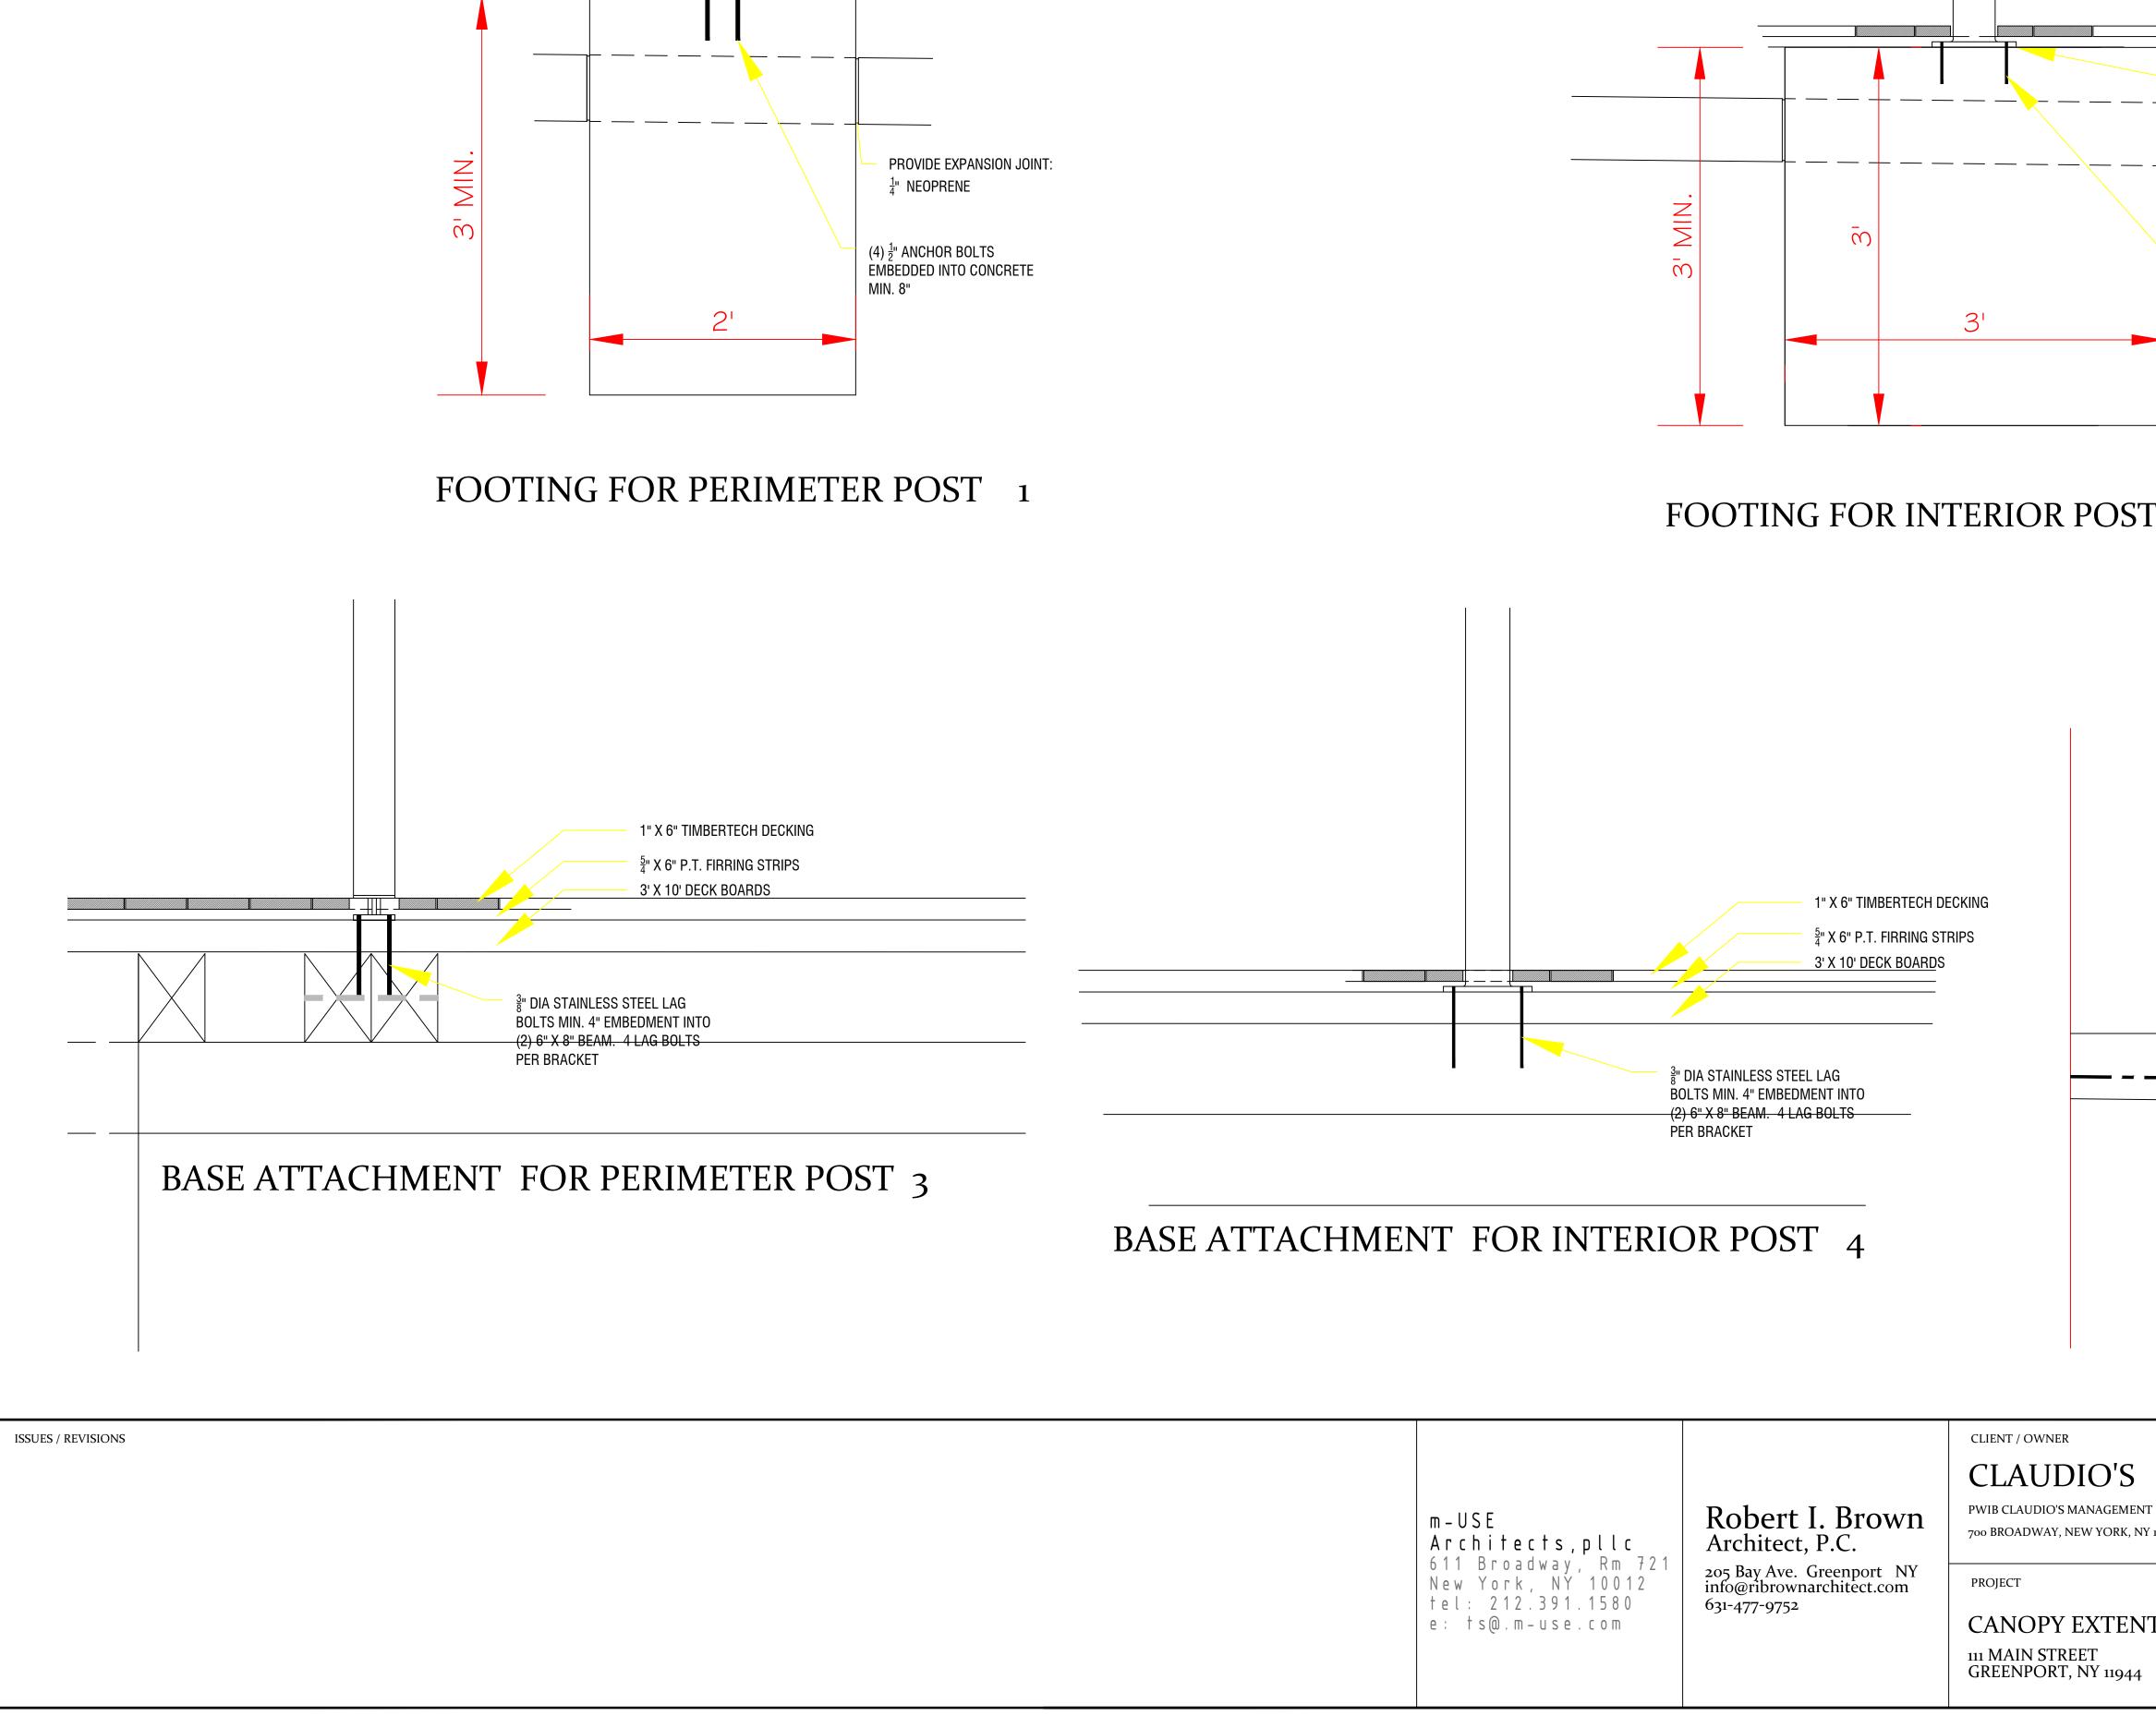


RECTANGULAR PERIMETER POST PROVIDED BY

MANUFACTURER

BASE CONNECTOR PROVIDED BY MANUFACTURER

4" x Stef	4" x ¹ 4" SQUARE TUBE EL COLUMN 1846 (ASTM)		
TUI AR 	(8" X ¹ / ₂ " STEEL BASEPLATE IM 1836 WELDED TO STEEI BES, ¹ / ₄ " FILLET WELDS ALL OUND. DVIDE EXPANSION JOINT: NEOPRENE ¹ / ₂ " ANCHOR BOLTS BEDDED INTO CONCRETE I. 8"		
Τ2			
	STEP DOWN TO EXPOSED CONCRETE		
	DETAIL 5		
VT IY 10003	drawing title DETAILS		drawing no.
ITION		IT IS A VIOLATION OF THE LAW FOR ANY PERSON, UNLESS ACTING UNDER THE DIRECTION OF A LICENSED ARCHITECT, TO ALTER ANY ITEM ON THIS DRAWING IN ANY WAY. ANY AUTHORIZED ALTERATIN MUST BE NOTED, SEALED AND DESCRIBED IN ACCORDANCE WITH THE LAW.	DATE SCALE DEC. 16, 2022 1-1/2" = 1'

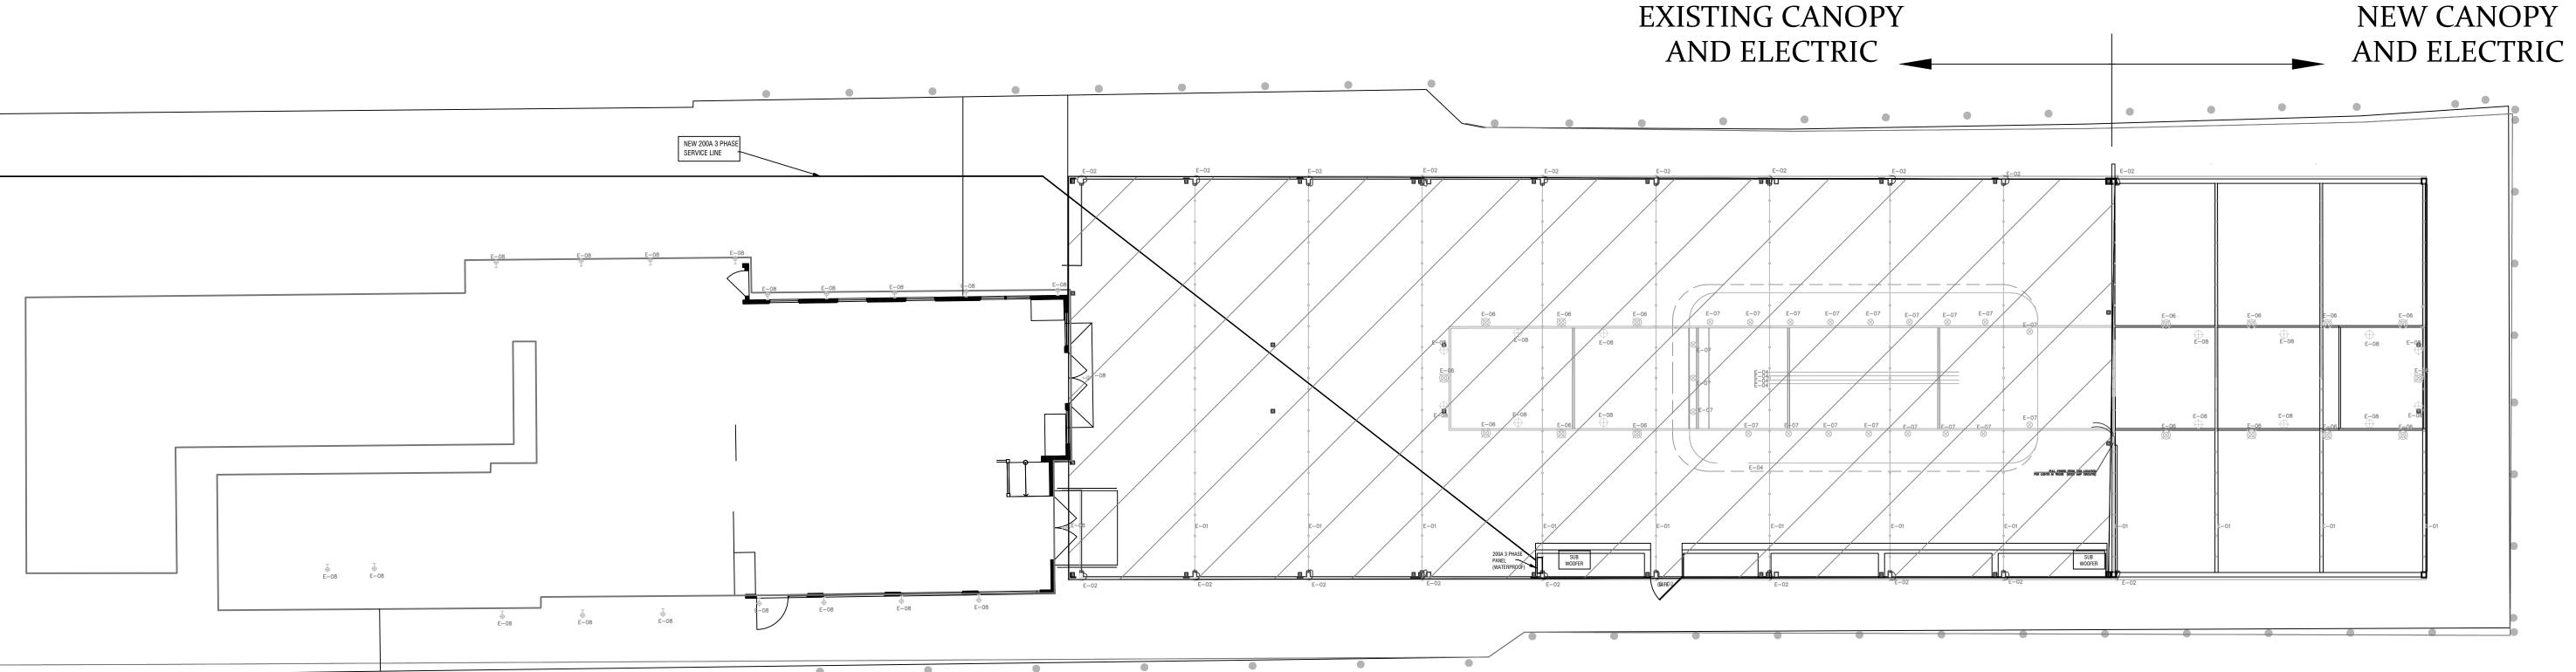

ELECTRICAL PLAN

2950 University

- E-OI String Lights 144.7 Each 100.8 Incandescent 2-wire
- E-02 Directional Sconce 20 7.5 Each 150 Electronic
- E-O3 Linear Perimeter Light 94 1.5W Foot 141 DMX E-O4 Linear Perimeter Light 22 GW Foot 132 DMX
- E-05 Rgb Spot Light 6 84 Each 504 DMX
- E-OG Rgb Moving Head 10 100w Each 1000 DMX
- E-07 Accent Light 20 15W Each 300 DMX
- E-08 Rgb Flood 5 166W Each 830 dmx
- E-09 Wall Mounted Gooseneck 19 20 Each 380 Incandescent 2 wire

ISSUES / REVISIONS

EXISTING CANOPY

GENERAL NOTES

1. CONTRACTOR TO RUN SPARE WIRE TO EVERY OUTLET FOR FUTURE LOCATION OF SWITCHED OUTLET. 2. CONTRACTOR TO COORDINATE

FIXTURE TRIM/ TRACK WITH CEILING FINISH FOR COMPLETE RECESS IN CEILING.

3. CONTRACTOR TO DETERMINE FINAL HOUSING ORIENTATION AND COORDINATE HOUSING TYPE AND ORIENTATION PER FIELD CONDITION TO SATISFY DESIGN INTENT.

4. CONTRACTOR TO VERIFY ALL WALLWASH FIXTURES ARE CORRECTLY ORIENTED TO LIGHT ARTWORK/ WALL PRIOR TO INSTALLATION.

5. CONTRACTOR TO COORDINATE TYPE, QUANTITY, AND LOCATION OF REMOTE POWER SUPPLIES AS PER MFR. AND REQUIREMENTS. REMOTE DRIVERS AS SPECIFIED NEED TO BE LOCATED IN AN ACCESSIBLE VENTILATED LOCATION AND AS BUILT OF THE DRIVER LOCATION CHART SHALL BE GIVEN TO LIGHTING DESIGNER FOR FUTURE REFERENCE.

6. ZONING ON PLAN ARE FOR DESIGN INTENT AND NOT WIRING PURPOSES.

7. FINAL LIGHTING LOCATION TO BE FIELD VERIFIED AND PLACEMENT CONFIRMED BASED ON SITE CONDITIONS AND DESIGN

8. CONTRACTOR TO LOCATE, PROVIDE AND INSTALL VACANCY SENSORS/ OCCUPANCY SENSORS AND EQUIPMENT ASSOCIATED WITH IT AS NEEDED TO FULFILL CODE REQUIREMENTS. SENSORS TO BE INSTALLED EITHER ABOVE THE CEILING FINISH/ WALL OR CONCEALED FROM VIEW.

9. CONTRACTOR TO INSTALL AND FURNISH VENTILATION PER ARCHITECT'S DRAWING

		F-01 RECESSED HAL. ADJ. ACCENT 1-L
	$\land \land$	F-02RECESSED HAL. ADJ. ACCENT 2-L
		F-03RECESSED CFL DOWNLIGHT
		F-04UNDERCABINET LED TASK LIGHT
		F-05RECESSED STEPLIGHT
		F-06 RECESSED LED WALL LIGHT
		F-07RECESSED HAL. LINEAR DOWNLIGH
		F-08 CURVABLE LED STRIP LIGHT
		F-09 CURVABLE LED STRIP LIGHT
		F-10 RECESSED HAL. DOWNLIGHT
		F-11 LINEAR LED STRIP LIGHT
		F-12 UNDERCABINET FLUOR. TASK LIGHT
		F-13 RECESSED HAL. ADJ. ACCENT 2-L
		F-14 RECESSED CFL DOWNLIGHT
		F-15 UNDERCABINET LED TASK LIGHT
		F-16 RECESSED STEPLIGHT
		F-17 RECESSED LED WALL LIGHT
		F-18 RECESSED HAL. LINEAR DOWNLIGH
		F-19 CURVABLE LED STRIP LIGHT
		F-20 RECESSED HAL. ADJ. ACCENT
	\bigcirc	F-21 RECESSED FLUOR. DOWNLIGHT
		F-22LINEAR LED STRIP LIGHT
		F-23RECESSED LINEAR DOWNLIGHT
		F-24RECESSED CFL DOWNLIGHT
		F-25 FLUORESCENT STRIP LIGHT
		F-26 RECESSED STEPLIGHT
		F-27 COLD CATHODE STRIPLIGHT
		F-28RECESSED HAL. LINEAR DOWNLIGH
		F-29 RECESSED WALLWASHER
		F-30 RECESSED HAL. WALLWASHER
		F-31 RECESSED HAL. ADJ. ACCENT
		A-XX PICTURE LIGHT

C-XX DECORATIVE SURFACE MOUNT

				UNLESS LABELED OTHERWISE. 3. CONTRACTOR TO VERIFY ALL WA FIXTURES ARE CORRECTLY ORIENTED TO INSTALLATION. 4. CONTRACTOR TO COORDINATE TY QUANTITY, AND LOCATION OF REMO POWER SUPPLIES AS PER MFR. AND REQUIREMENTS.	D PRIOR YPE, DTE		
Architectural Lighting DesignA21 West 39th Street, 2A6New York, NY 10018NP: 212-563-09941	n–USE Architects,pllc 511 Broadway, Rm 721 New York, NY 10012 Tel: 212.391.1580 e: ts@.m–use.com	Robert I. Brown Architect, P.C. 205 Bay Ave. Greenport NY info@ribrownarchitect.com 631-477-9752	CLIENT / OWNER CLAUDIO'S PWIB CLAUDIO'S MANAGEMENT 700 BROADWAY, NEW YORK, NY 10003 PROJECT CANOPY EXTENTION 111 MAIN STREET GREENPORT, NY 11944	DRAWING TITLE ELECTRICAL PLAN	IT IS A VIOLATION OF THE LAW FOR ANY PERSON, UNLESS ACTING UNDER THE DIRECTION OF A LICENSED ARCHITECT, TO ALTER ANY ITEM ON THIS DRAWING IN ANY WAY. ANY AUTHORIZED ALTERATIN MUST BE NOTED, SEALED AND DESCRIBED IN ACCORDANCE WITH THE LAW.	DRAWING No.	SCALE $1/8'' = 1'$

. ADJ. ACCENT 1—LAMP . ADJ. ACCENT 2—LAMP	\bigotimes	L-XX	DECORATIVE FLOOR LAMP
DOWNLIGHT LED TASK LIGHT	\oplus	P-XX	DECORATIVE PENDANT
PLIGHT WALL LIGHT	₽	S-XX	DECORATIVE SCONCE
. LINEAR DOWNLIGHT STRIP LIGHT	M	R-XX	READING LIGHT
STRIP LIGHT	\otimes	т-хх	DECORATIVE TABLE LAMP
. DOWNLIGHT RIP LIGHT	$(\forall \forall)$		WIRE WHIP
FLUOR. TASK LIGHT	T		REMOTE POWER SUPPLY
. ADJ. ACCENT 2-LAMP	S		SHADE MOTOR POWER FEED
DOWNLIGHT	F		SHADE MOTOR POWER FEED
LED TASK LIGHT	r		STADE MOTOR FOWER FEED
PLIGHT	—		SWITCHED WALL DECEDIACIE
WALL LIGHT	-		SWITCHED WALL RECEPTACLE
. LINEAR DOWNLIGHT			CHITCHED FLOOD DECEDIANE
STRIP LIGHT	CLOCK		SWITCHED FLOOR RECEPTACLE
L. ADJ. ACCENT	\$ =		CLOCK RECEPTACLE
OR. DOWNLIGHT	Πņ		LUTRON 300W PLUG-IN TABLETOP DIMMER
RIP LIGHT	(205 KP-E)		LUTRON WALL MOUNTED KEYPAD
EAR DOWNLIGHT DOWNLIGHT	206 KP-0	-	LUTRON TABLETOP KEYPAD
STRIP LIGHT	205-01		LIGHTING CONTROL ZONE
PLIGHT		_ /	SHADE/DRAPERY CONTROL ZONE
STRIPLIGHT	SH-205-0		SHADE/DRAFERT CONTROL ZONE
. LINEAR DOWNLIGHT	\$ _{DJ}		JAMB-OPERATED SWITCH
LWASHER	\$ _{мs}		LUTRON MAESTRO SWITCH
. WALLWASHER	\$ _{MR}		LUTRON MAESTRO REMOTE SWITCH
. ADJ. ACCENT	\$ _{vs}		WALL SWITCH W/VACANCY SENSOR
	\$ _{DVS}		WALL DUAL RELAY SWITCH W/ VACANCY SENSOR & NIGHT LIGHT (WATTSTOPPER CS-350-N PIR)
IDEAOE MOUNT	VS		VACANCY SENSOR
JRFACE MOUNT	EVERY	OUTL	TOR TO RUN SPARE WIRE TO ET FOR FUTURE LOCATION OF UTLET

SWITCHED OUTLET.

2. ALL NEW FIXTURES IN NEW LOCATIONS