



236 THIRD STREET **GREENPORT, NY 11944**

Tel: (631)477-0248 Fax: (631)477-1877

villageofgreenport.org

MAYOR

KEVIN STUESSI

MARY BESS PHILLIPS

DEPUTY MAYOR

PATRICK BRENNAN

LILY DOUGHERTY-JOHNSON

TREASURER ADAM BRAUTIGAM EXT. 217

VILLAGE CLERK CANDACE HALL **EXT 214** ZONING BOARD OF APPEAL BOILDING DEPARTMENT NOTICE OF DISAPPROVAL

FROM: VILLAGE OF GREENPORT BUILDING DEPARTMENT

APPLICANT: ANDREW MCCULLOCH

ADDRESS: 616 MAIN STREET

SCTM: 1001-003-004-004

EXT 215 DATE: JUNE 20, 2025

TRUSTEES BUILDING FILE #24-041

The building permit application for CONSTRUCTING A SECOND FLOOR WOOD DECK at the above-mentioned premises has been denied for the

following reasons:

JULIA ROBINS The combined side yard setbacks require 25'. You have a combination of 16.5' therefore you will need a variance of 8.5'.

> George Pfriender **Building Inspector**



of material, where applicable.

ZONING BOARD OF APPEALS APPLICATION

AREA VARIANCE

236 Third Street, Greenport, New York, 11944 (631) 477-0248 www.villageofgreenport.org

JUL 0 2 2025

VILLAGE OF GREENPORT
BUILDING DEPARTMENT

Date of Application 06/22/2025

All information below is to be completed by the applicant. This completed application is to be accompanied by the Notice of Disapproval, Copies of Covenants and/or Restrictions, where applicable, Environmental Assessment Form, building plans showing elevations, setbacks, floor plans, room dimensions, details of footings and foundation, and species of lumber and quality

Andrew	McCulloch				was the same
First Name	Last Name		Business N	ame, if ap	plicable
			N	٧Y	
Mailing Address		City/ Town/ Village	S	State	Zip
Phone #		E-Mail Address	gmail.com		
	ON (if different from all correspondence:	owner)			
The person to receive o		owner)	Business N	ame, if ap	pplicable
CONTACT PERSO The person to receive of First Name Mailing Address	all correspondence:	City/ Town/ Village		ame, if ap	oplicable Zip
The person to receive of First Name	all correspondence:		S		
The person to receive of First Name Mailing Address Phone # IF ANYONE OTHER	all correspondence: Last Name R THAN THE OWNE	City/ Town/ Village	S S PPLICATION	State	Zip
The person to receive of First Name Mailing Address Phone # IF ANYONE OTHER	all correspondence: Last Name R THAN THE OWNE	City/ Town/ Village E-Mail Addres	S S PPLICATION	State	Zip
The person to receive of First Name Mailing Address Phone # IF ANYONE OTHER FROM THE OWNER Location:	AL CORRESPONDENCE: Last Name R THAN THE OWNER MUST BE SUBMIT	City/ Town/ Village E-Mail Addres	S PPLICATION ICATION.	State	Zip





ZONING BOARD OF APPEALS APPLICATION

AREA VARIANCE

236 Third Street, Greenport, New York, 11944

(631) 477-0248

www.villageofgreenport.org

The Code Official reviewed and denied an application dated <u>4/1/2025</u> for a Building Permit for the location specified on this application.					
Provisions of the Zoning Code appealed: (Indicate Article, Section and Subsection of Zo	oning Code by ni	umbers)			
Article:	Section: 150 -		Subsection:		
Type of appeal made for: [] A Variance to the Zoning Code or Zoning I [] An interpretation of the Village Code Artic	Мар. le:	Section:	Subsection:		
Has a prior appeal been made at any time w If yes, please provide the date appeal was made	vith respect to t	his proper	ty? [] Yes [X] No [] I Don't Know		
Project Description:					
Extend the landing at the rear of the second f	loor into a deck	across the i	rear of the house.		
For Demolition of Existing Building Areas	Please describe	area being ro	emoved:		
Not applicable. The second floor does not currently have a rear deck.					
New Construction Areas (New	Dwelling or	New	Addition/Extensions)		
Dimensions of First Floor (Addition/Extension): N/A Dimensions of Second Floor (Addition/Extension): 75 SqFt (Addition of Rear Deck)					
Height (from finished grade to top of ridge): _	Feet, _	Inc	ches		
Is basemnt or lowest floor area being const If yes, please provide height (above ground) n	ructed? [] Yes neasured from n	M No atural exist	ting grade to first floor:		





ZONING BOARD OF APPEALS APPLICATION

AREA VARIANCE
236 Third Street, Greenport, New York, 11944 (631) 477-0248 www.villageofgreenport.org

Project Description: (CONTINUED)
Proposed Construction Description: (Alteration or Structural Changes)
Number of floors BEFORE alterations: 2
Describe General Characteristics BEFORE alterations:
The second floor has a rear entrance with a staircase leading to second floor.
Number of floors AFTER Alterations:2
Describe General Characteristics AFTER alterations:
Extension of the landing at the rear of the second floor into a deck across the rear of the house for the
second floor apartment.
Calculations of Building Areas and Lot Coverage:
Existing Square Footage of Building(s) on this property: 1500 SqFt
Proposed Increase in Building Coverage: <u>0 SqFt</u>
Square Footage of this Lot: 5671 SqFt
Percentage of Coverage of this Lot by Building Area: 26%
Purpose of New Construction: Please describe: Add an outdoor deck to the second floor so each of the two apartments have their own private exterior spaces.



ZONING BOARD OF APPEALS APPLICATION

AREA VARIANCE
236 Third Street, Greenport, New York, 11944 (631) 477-0248 www.villageofgreenport.org

	Area Variance Reasons for Appeal:
	Please answer in detail. Additional sheets maybe submitted with preparers signature.
A	Will an undesirable change occur in the characteristics of the neighborhood or will a detriment
	to nearby properties be created by the granting of this area variance?
	No.
	Can the benefit sought by the Applicant be achieved by another method, feasible for the Applicant to pursue, other than an Area Variance?
	No.
	110.
	Is the requested Area Variance substantial?
	No. The majority of the proposed rear porch will be over an existing front floor porch.
	The majority of the proposed team person with the first team of th
	Will the requested Area Variance have an adverse effect or impact on the physical or
	environmental conditions in the neighborhood or district?
	No.
	Was the alleged difficulty self-created, which consideration shall be relevant to the decision of the

Zoning Board of Appeals, but shall not neessarily preclude the granting of the Area Variance? No Are there Covenants or Restrictions concerning this land? [] Yes [] No If yes, please furnish copies.

AFFIDAVIT

Village of Greenport)
Town of Southold)
County of Suffolk) ss
State of New York)

I swear that to the best of my knowledge and belief that the statements contained in this application, together with the plans and specifications submitted, are true and complete statements of proposed work to be done on the described premises and that all provisions of the Building Code, Zoning Code, and all other laws pertaining to the proposed work shall be complied with, whether specified of not, and that such work and inspections are authorized by the owner. The Village of Greenport is hereby granted permission to enter the property listed as the "Location" for the purposes of inspecting my property for a site visit. I understand that if approved, this Area Variance will be granted and accepted on condition that the provisions of Federal, State and Local rules and regulations, and any additional requirements of the Area Variance are complied with. Any violation of all applicable codes, or deviations from the approved plans may result in the immediate revocation of this Area Variance & legal action taken against me. No responsibility rests upon the Village of Greenport, Code Enforcement, the Fire Marshal or the Fire Department by reason of this application and permit.

Sworn to be before this	23 rd day	Signature	
of June	20 25	,	Owner or Applicant

Notary Public, Suffolk County, New York

TIFFANY J BEREZNY
Notary Public - State of New York
No. 018E6284112
Qualified in Suffolk County
My Commission Expires 06/17/2029

617.20 Appendix B Short Environmental Assessment Form

Instructions for Completing

Part 1 - Project Information. The applicant or project sponsor is responsible for the completion of Part 1. Responses become part of the application for approval or funding, are subject to public review, and may be subject to further verification. Complete Part 1 based on information currently available. If additional research or investigation would be needed to fully respond to any item, please answer as thoroughly as possible based on current information.

Complete all items in Part 1. You may also provide any additional information which you believe will be needed by or useful to the lead agency; attach additional pages as necessary to supplement any item.

Part 1 - Project and Sponsor Information					
Name of Action or Project:	***************************************	A CONTRACTOR OF THE PARTY OF TH			
616 Main St Renovation					
Project Location (describe, and attach a location map):					
616 Main St, Greenport, NY 11944					
Brief Description of Proposed Action:		1 - 1 - 1			
Extension of the current landing at the rear of the second floo	r into	a deck along			
the back of the house.					
Name of Applicant or Sponsor:	Telepho	one			
Andrew McCulloch	E-Mail		@gr	mail.c	om
Address:					
			T =:		
City/PO:		State: NY		Code: 1249	
Brooklyn			1		VEC
1. Does the proposed action only involve the legislative adoption of a plan, lo administrative rule, or regulation?	ocal law,	, ordinance,		NO	YES
If Yes, attach a narrative description of the intent of the proposed action and	the envi	ronmental resources t	hat	X	П
may be affected in the municipality and proceed to Part 2. If no, continue to	question	1 2.			
2. Does the proposed action require a permit, approval or funding from any	other go	vernmental Agency?		NO	YES
If Yes, list agency(s) name and permit or approval:					X
Greenport HPC. COA granted on 1/27/2025.					
J.a. Total acteage of the site of the proposed action:	.130	acres			
b. Total acreage to be physically disturbed? c. Total acreage (project site and any contiguous properties) owned	0.002	acres			
or controlled by the applicant or project sponsor?	.132	_acres			

4. Check all land uses that occur on, adjoining and near the proposed action. Urban Rural (non-agriculture) Industrial Comm	ercial	Residential (subur	ban)		
,		:			
Parkland	,				

Page 1 of 4

5. Is the proposed action.	YES	DI/A
5. Is the proposed action, a. A permitted use under the zoning regulations?	X	N/A
b. Consistent with the adopted comprehensive plan?	X	
6. Is the proposed action consistent with the predominant character of the existing built or natural	NO	YES
landscape?		×
7. Is the site of the proposed action located in, or does it adjoin, a state listed Critical Environmental Area? If Yes, identify:	NO	YES
11 Tos, (dollar)	×	
8. a. Will the proposed action result in a substantial increase in traffic above present levels?	NO	YES
	X	Ш
b. Are public transportation service(s) available at or near the site of the proposed action?	X	
c. Are any pedestrian accommodations or bicycle routes available on or near site of the proposed action?	X	
9. Does the proposed action meet or exceed the state energy code requirements? If the proposed action will exceed requirements, describe design features and technologies:	NO	YES
If the proposed action will exceed requirements, describe design realities and technologies.		X
	1	
10. Will the proposed action connect to an existing public/private water supply?	NO	YES
If No, describe method for providing potable water:		×
11. Will the proposed action connect to existing wastewater utilities?	NO	YES
If No, describe method for providing wastewater treatment:		X
The state of the s	NO	YES
12. a. Does the site contain a structure that is listed on either the State or National Register of Historic Places?		X
b. Is the proposed action located in an archeological sensitive area?	×	
13. a. Does any portion of the site of the proposed action, or lands adjoining the proposed action, contain	NO	YES
wetlands or other waterbodies regulated by a federal, state or local agency?	X	
b. Would the proposed action physically alter, or encroach into, any existing wetland or waterbody?	×	
If Yes, identify the wetland or waterbody and extent of alterations in square feet or acres:		
14. Identify the typical habitat types that occur on, or are likely to be found on the project site. Check all that	apply:	
☐ Shoreline ☐ Forest ☐ Agricultural/grasslands ☐ Early mid-successional		
☐ Wetland ☐ Urban ☑ Suburban	NO	YES
15. Does the site of the proposed action contain any species of animal, or associated habitats, listed by the State or Federal government as threatened or endangered?		TES
	X	VEC
16. Is the project site located in the 100 year flood plain?	NO	YES
17. Will the proposed action create storm water discharge, either from point or non-point sources?	NO	YES
If Yes,	×	
b. Will storm water discharges be directed to established conveyance systems (runoff and storm drains)? If Yes, briefly describe: NO YES		
If Yes, briefly describe:		

Page 2 of 4

8. Does the proposed action include construction or other activities that result in the impoundment water or other liquids (e.g. retention pond, waste lagoon, dam)?	of I	NO	YES
f Yes, explain purpose and size:		×	
9. Has the site of the proposed action or an adjoining property been the location of an active or closolid waste management facility? f Yes, describe:		NO	YES
		×	Ш
20. Has the site of the proposed action or an adjoining property been the subject of remediation (on completed) for hazardous waste? f Yes, describe:	going or	NO X	YES
AFFIRM THAT THE INFORMATION PROVIDED ABOVE IS TRUE AND ACCURATE KNOWLEDGE		est o	FMY
Applicant/sponsor name: Andrew McCulloch Signature: Date:	3/2023		
responses been reasonable considering the scale and context of the proposed action?"			
	No, or small impact may	to	derate large apact may
	small impact	to	large npact
Will the proposed action create a material conflict with an adopted land use plan or zoning regulations?	small impact may	to	large npact may
 Will the proposed action create a material conflict with an adopted land use plan or zoning regulations? Will the proposed action result in a change in the use or intensity of use of land? 	small impact may	to	large npact may
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 Will the proposed action create a material conflict with an adopted land use plan or zoning regulations? Will the proposed action result in a change in the use or intensity of use of land? Will the proposed action impair the character or quality of the existing community? Will the proposed action have an impact on the environmental characteristics that caused the establishment of a Critical Environmental Area (CEA)? Will the proposed action result in an adverse change in the existing level of traffic or affect existing infrastructure for mass transit, biking or walkway? Will the proposed action cause an increase in the use of energy and it fails to incorporate reasonably available energy conservation or renewable energy opportunities? Will the proposed action impact existing: a. public / private water supplies? 	small impact may	to	large npact may
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NO YES

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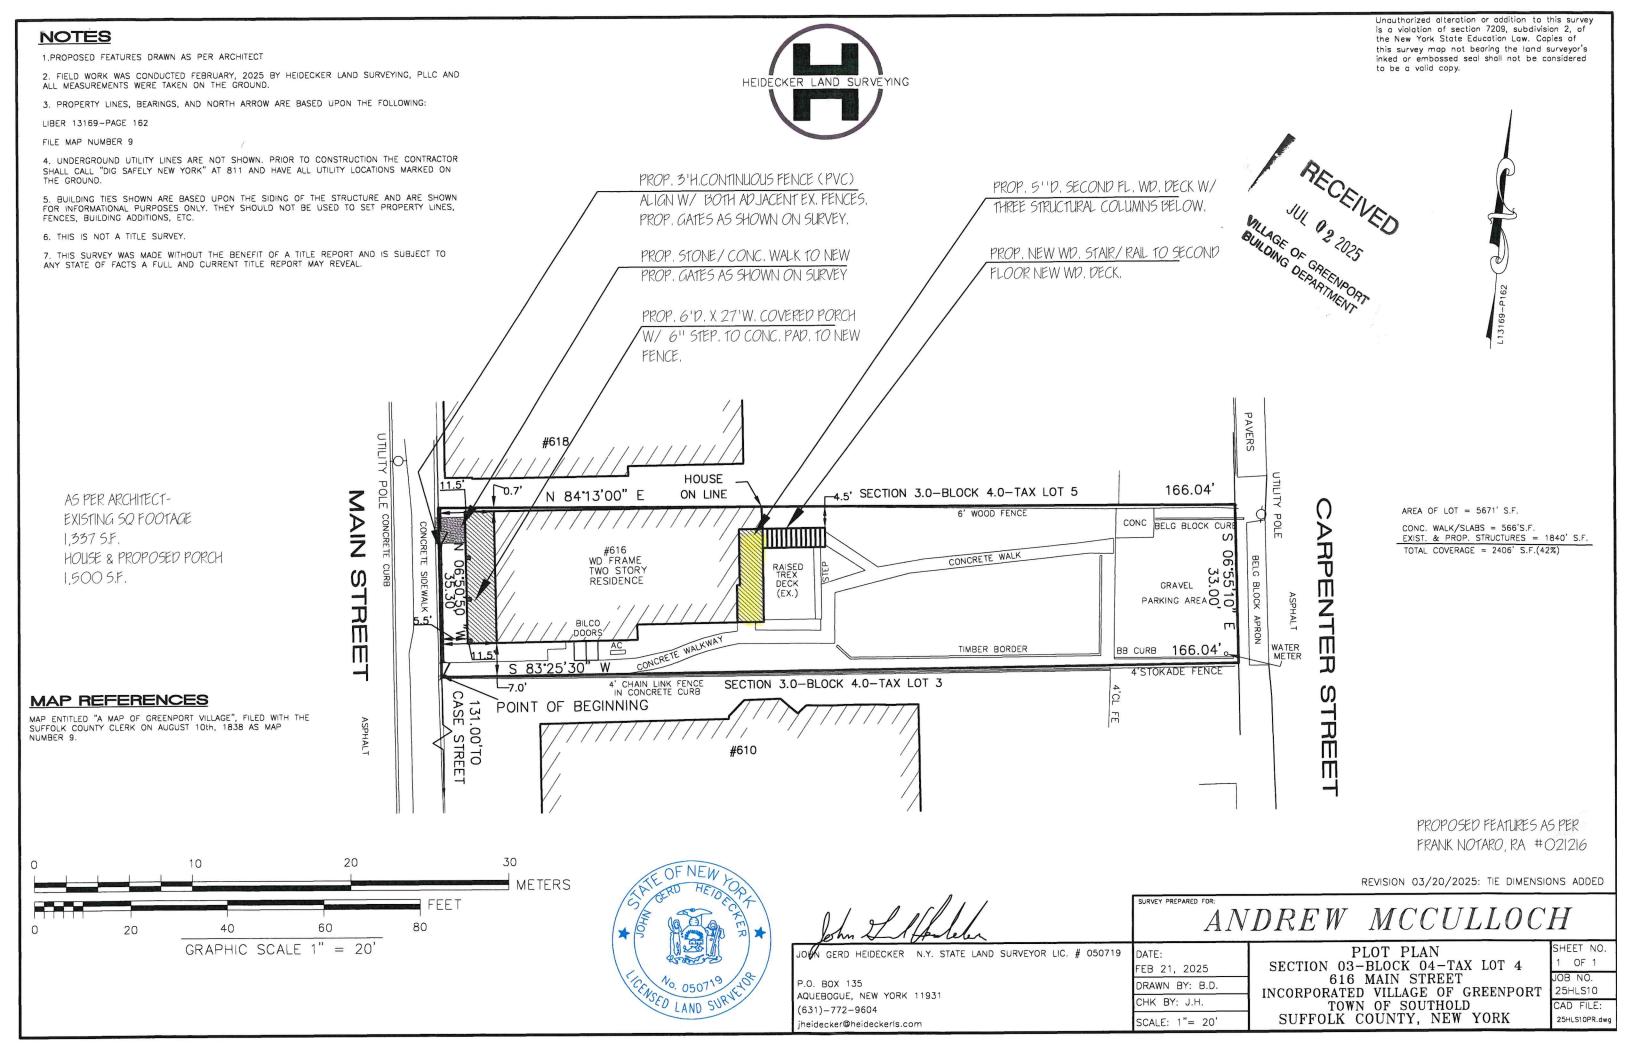
	No, or small impact may occur	Moderate to large impact may occur
10. Will the proposed action result in an increase in the potential for erosion, flooding or drainage problems?		
11. Will the proposed action create a hazard to environmental resources or human health?		

Part 3 - Determination of significance. The Lead Agency is responsible for the completion of Part 3. For every question in Part 2 that was answered "moderate to large impact may occur", or if there is a need to explain why a particular element of the proposed action may or will not result in a significant adverse environmental impact, please complete Part 3. Part 3 should, in sufficient detail, identify the impact, including any measures or design elements that have been included by the project sponsor to avoid or reduce impacts. Part 3 should also explain how the lead agency determined that the impact may or will not be significant. Each potential impact should be assessed considering its setting, probability of occurring, duration, irreversibility, geographic scope and magnitude. Also consider the potential for short-term, long-term and cumulative impacts.

Check this box if you have determined, based on the information and analysis above, and any supporting documentation, that the proposed action may result in one or more potentially large or significant adverse impacts and an environmental impact statement is required. Check this box if you have determined, based on the information and analysis above, and any supporting documentation, that the proposed action will not result in any significant adverse environmental impacts.				
Name of Lead Agency	Date			
Print or Type Name of Responsible Officer in Lead Agency	Title of Responsible Officer			
Signature of Responsible Officer in Lead Agency	Signature of Preparer (if different from Responsible Officer)			

PRINT

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1/4" = 1-0"

DWG. NAWE EXISTING ELEVATIONS

A-EX.I




FRONT ELEVATION



RIGHT ELEVATION




FRONT ELEVATION

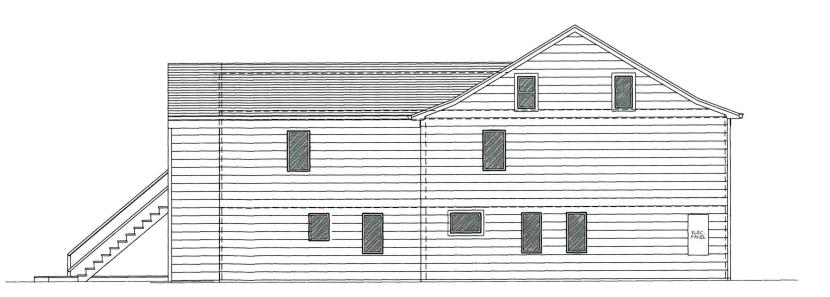

LEFT ELEVATION



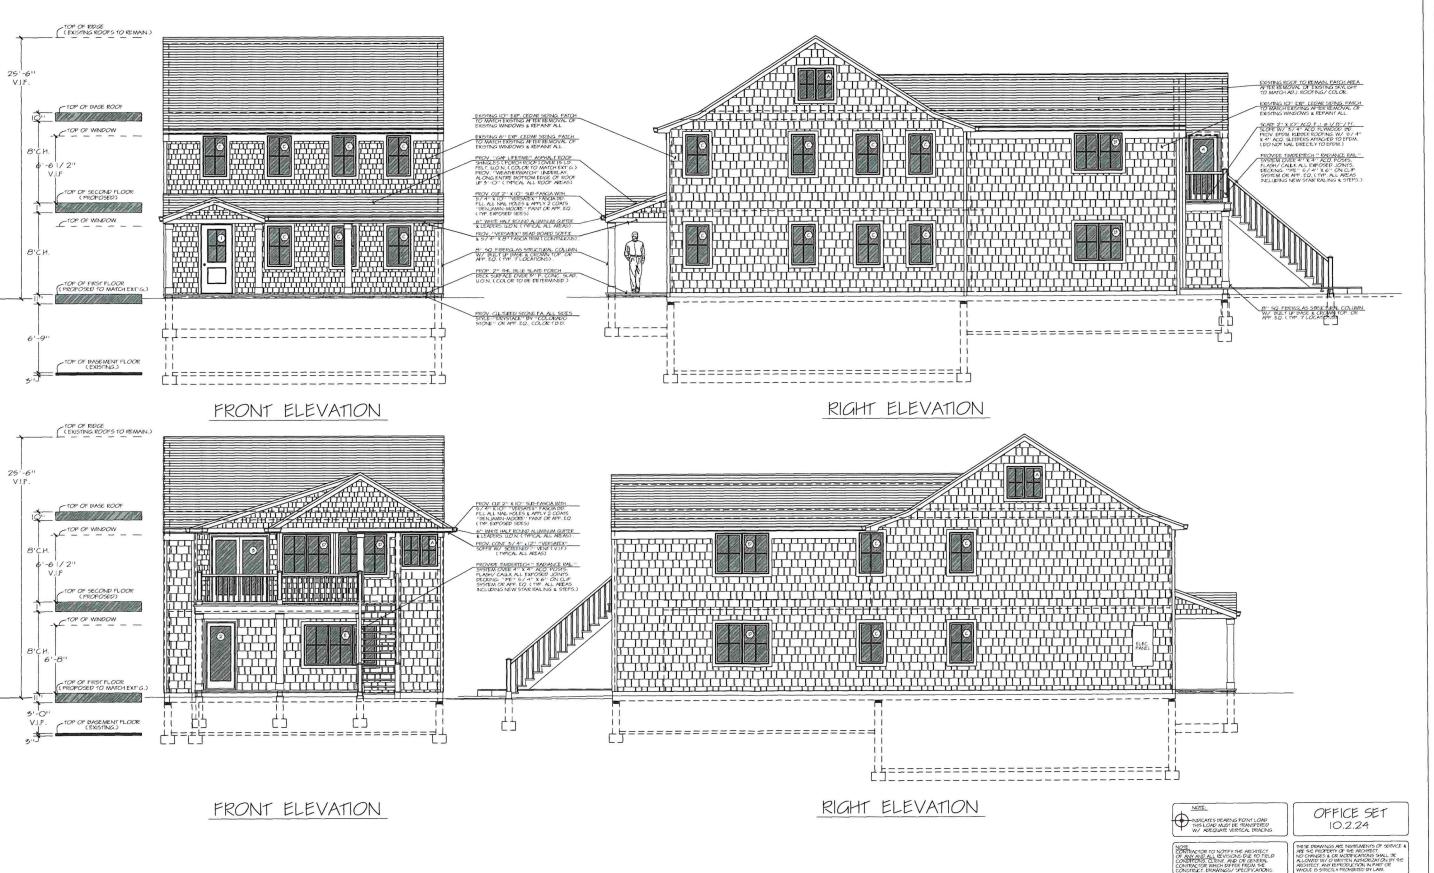

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であり、 PROPOSED ALTERATION TO:

ST. / McCULLOCH
NEW YORK MAIN

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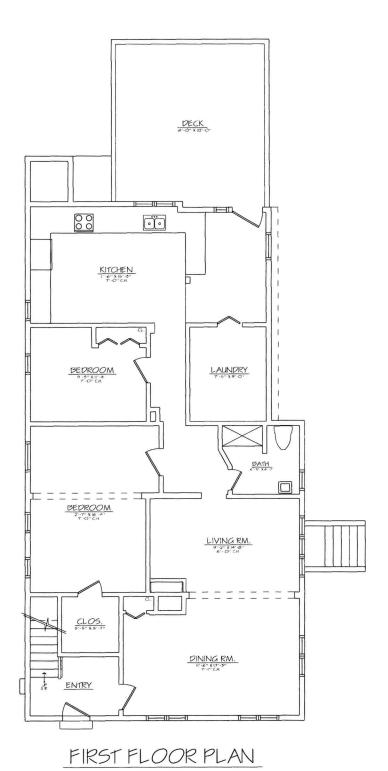
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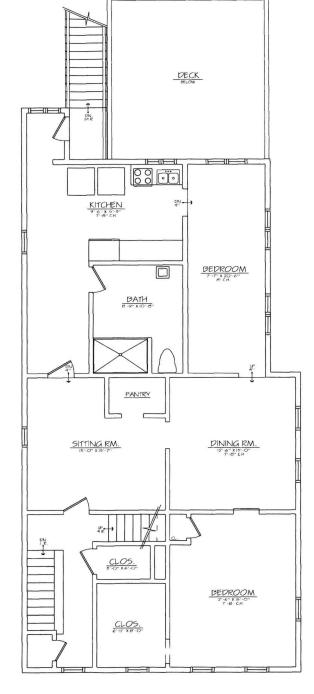
DWG. NO.: A-3

GENERAL NOTES

- I. ALL WORK PERFORMED SHALL DE IN COMPLIANCE WITH ALL FEDERAL, STATE & LOCAL BUILDING CODES AND ORDINANCES.
- 5. THE CONTRACTORS SHALL BE RESPONSIBLE FOR ALL DIMENSIONS & CONDITIONS ON THE LOB. THE ARCHITECT MUST BE NOTIFIED OF ANY VARIATIONS FROM THE DIMENSIONS SHOWN.
- 4. THE CONTRACTOR SHALL SUPPLY ALL LABOR AND MATERIAL SHOWN ON THE DRAWINGS LINLESS OTHERWISE NOTED.
- 5. THE CONTRACTOR SHALL BE RESPONSIBLE FOR ADEQUATELY DRACING & PROTECTING ALL WORK DILLING CONSTRUCTION AGAINST DAMAGE, BREAKAGE, COLLAPSE, DISTORTION & MISCLURINERIN ACCORDING TO ALL APPLICABLE STATE AND LOCAL CODES.
- 6. THE GEN'L. CONTRACTOR SHALL PRY FOR ALL PERMITS. FEES, & COSTS RELATED TO THE WORK OF THIS CONTRACT THE GENERAL CONTRACTOR SHALL INITIATE ALL RECURED INSPECTIONS OF ALL WORK COMPLETED LADDER THIS CONTRACT LINESS OTHERWISE NOTED.
- 7. THE SUB-CONTRACTORS SHALL AT ALL TIMES KEEP THE PREMISES CLEAN AND ARE RESPONSIBLE FOR REMOVAL OF ALL RUPPISH CREATED BY THEIR INDIVIDUAL TRADES ILO.N.
- 8. ANY "EXTRAS" FOR ANY AND ALL PIELD CONDITIONS/ SUBSTANTIAL CHANGES SHALL BE DOCUMENTED WITH THE COST ESTIMATE & APPROVED BY OWNER AND OR HIS AGENT BEFORE STARTISCA THE ADDITIONAL WORK.
- 9. DOUBLE FLOOR JOISTS ARE 10 DE INSTALLED UNDER ALL WALL PARTITIONS RIANING PARALLEL 10 THE FRAMING, PROVIDE DOUBLE HOR. JOISTS AT ALL OPENINGS REPER 10 CONSTRUCTION DWAYS FOR SIZES.
- IO. ALL FRAMING LIMBER TO BE DOUGLAS FIR # 2 CONST. GRADE OR EO.
- II. ALL EXTERIOR STRAPPING TO BE ABOVE OR BENEATH EXTERIOR STEATHING.
- 12. THE CONTRACTOR SHALL PROVIDE SHOP DRAWINGS FOR ALL SPECIAL WORK SUCH AS BUI NOT LIMITED TO: MILLWORK, SPRINGLER SYSTEMS AND STEEL WORK, ALL SHOP DRAWINGS NEED THE APPROVAL OF THE ARCHITECT PRICK TO PROCEEDING, WITH THE WORK.

PER REQUIREMENTS BY the NEW YORK STATE RESIDENTIAL CONSTRUCTION CODE, WE CERTLY THAT THE PESIGN CENTERALS DONE PER PRESCRIPTIVE RESIGN ALL OF THE LOAD CACLEL ARROWS & STRUCTURE, PLANS COMPLY WITH ALL OF NEW YORK STATE CONSTRUCTION CODE DASED ON CAFERA.)





SECOND FLOOR PLAN

ELECTRICAL LEGEND

NOTE: ALL ELECTRICAL WORK TO BE IN ACCORPANCE WITH THE RALES & REGULATIONS OF THE NYBFILL AND A CERTIFICATE FROM THE NYBFILL IS TO BE PRESENTED TO THE OWNER AT THE COMPLETION OF THE JOB. THE OWNER SHALL PROVIDE ALL SUIT ACE MOUNTED LIGHT FIXTURES. ALL OTHER ELECTRICAL EQUIP. TO BE SUPPLIED BY ELECTRICAL CONTRACTOR.

ALL SWITCHES AND RECEPTACLES TO BE "LUTRON", "DECORA" COLOR T.B.D. RECESSED DOWNLIGHTS TO BE "LIGHTOLIER" OR APP. EQ. TRIM - WHITE-BY! NOTE: CONTRACTOR SHALL PROVIDE DIMMER SMITCHES FOR ALL RECESS. DOMNLIGHTS, VERRY LOCATIONS OF ALL ELEC. DEVICES WITH CLIENT.

OGIE

VISTALCTION SERVICES

Now York 11971
Adoless@witer.com

ITECNOL ARCHITECTURE PLANNING CONS

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McCULLOCH

ST.

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SCALE: 1/4" = 1'-0"

EXISTING FIRST, SECOND & ATTIC FLOOR PLANS


DWG. NAME:

DWG. NO.: A-EX

- DUPLEX ELECTRICAL RECEPTACLE
- \$ DOUBLE PUPLEX ELECTRICAL RECEPTACLE
- \$50 DUPLEX SEPARATE CIRCUIT RECEPTACLE
- DUPLEX RECEPTACLE / GROUND FAULT INTERRUPT

 WALL SWITCH
- \$ 5-WAY WALL SWITCH
- \$25 RECESSED DOOR ACTIVATED SWITCH

 RECESSED DOWNLIGHT (LOOW) " LIGHTOLIER" OR APP. EQ.
- EXTERIOR RECESSED DOWNLIGHT (100W) "LIGHTOLER" OR APP. EQ.
- $igoplus_{\mathbf{p}}$ celing mounted junction box D. WALL MOUNTED JUNCTION BOX
- THE WALL MOUNTED DUAL SPOTLIGHT
- NEW CELLING MOUNTED JUNCTION BOX FOR SURFACE FAIL/ LIGHT
 WITH DUAL SWITCH AT WALL, FIXTURE TO BE SUPPLIED BY OWNER.
- HE NEW CELLING MOUNTED JUNCTION DOX FOR RECESSED EXHAUST FANZ LIGHT WITH DUAL SWITCH AT WALL, "PROAN" HEAVY DUTY UNIT OR APP. EQUAL.
- ${\bf d}_{_{\rm C}}$ NEW CAPLE TO RECEPTACLE (10 DE WRED TO CENT. CONTROL BOX) ${\bf d}_{_{\rm M}}$ NEW STRILLTIMED CASLE (10 DE WRED TO CENT. CONTROL BOX)
- SMOKE / CARDON MONOXIDE DETECTOR: TO BE WIRED TO CENTRAL CONTROL DOX.
- E NEW DOORBELL
- NOTE: ALL OUTLETS IN GARAGE AREA TO BE ON A S.C.

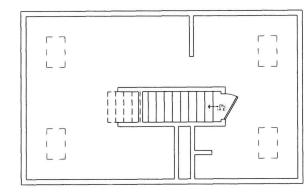

ATTIC FLOOR PLAN

OFFICE SET 10.2.24

NOTE:



- . ALL WORK PERFORMED SHALL BE IN COMPLIANCE WITH ALL FEDERAL, STATE & LOCAL BUILDING CODES AND ORDINANCES.
- 3. THE CONTRACTORS SHALL BE RESPONSIBLE FOR ALL DIMENSIONS & CONDITIONS ON THE JOB. THE MICHTECT MUST BE NOTIFIED OF ANY VARIATIONS FROM THE DIMENSIONS SHOWN
- 4. THE CONTRACTOR SHALL SUPPLY ALL LABOR AND MATERIAL SHOWN ON THE DRAWINGS UNLESS OTHERWISE NOTED. 5. THE CONTRACTOR SHALL DE RESPONSIBLE FOR ADECHATELY PRACING & PROTECTING ALL WORK DIRING CONSTRUCTION AGAINST DRAWASE, WIBARAGE, COLLAMSE, DISTORTION & MISALIZAMENT ACCORDING TO ALL APPLICABLE STATE AND LOCAL COPIED.
- 6. THE CENTL, CONTRACTOR SHALL PAY FOR ALL PERMITS, FEES, & COSTS RELATED TO THE WORK OF THIS CONTRACT. THE CENERAL CONTRACTOR SHALL INITIATE ALL REQUIRED INSPECTIONS OF ALL WORK COMPLETED INVERT HAS CONTRACT UNLESS OTHERWISE NOTED.
- 7. THE SUB-CONTRACTORS SHALL AT ALL TIMES KEEP THE PREMISES CLEAN AND ARE RESPONSIBLE FOR REMOVAL OF ALL RUBBISH CREATED BY THEIR INDIVIDUAL TRADES LLO.N.
- 8. ANY "EXTRAG" FOR ANY AND ALL FIELD CONDITIONS / SUBSTANTIAL CHANGES SHALL BE DOCUMENTED WITH THE COST ESTIMATE & APPROVED BY OWNER AND OR HIS AZENT DEFORE SYMPTICS THE ADDITIONAL WORK.
- 9. DOUBLE FLOOR JOISTS ARE TO BE INSTALLED UNDER ALL WALL PARTITIONS KINNING PARALLEL TO THE FRAMING, PROVICE GOUBLE HOR. JOISTS AT ALL OPENINGS, REFER TO CONSTRUCTION DWG'S FOR SIZES.
- IO. ALL FRAMING LUMBER TO BE DOUGLAS FIR #2 CONST. GRADE OR EQ. II. ALL EXTERIOR STRAPPING TO BE ABOVE OR BENEATH EXTERIOR SHEATHING
- 12. THE CONTRACTOR SHALL PROVIDE SHOP DRAWINGS FOR ALL SPECIAL WORK SUCH AS BUT NOT LIMITED TO: MULLWORK, SPENKLER SYSTEMS AND STEEL WORK, ALL SHOP DRAWINGS NEED THE APPROVAL OF THE ARCHITECT PRICK TO PROCEEDING WITH THE WORK.


NOTE

PER REQUIREMENTS BY THE NEW YORK STATE RESIDENTIAL CONSTRUCTION CODE, WE CERTIFY THAT THE DESIGN CRITERIA IS DONE PER PRESCRETIVE DESIGN, ALL OF THE LOAD CALCULATIONS AS STRUCTURE PLANS COMPLY WITH ALL OF NEW YORK STATE CONSTRUCTION CODE BASED ON C. AFRIPA.)

REFERENCE NOTES:

- THE PROVIDE NEW WOOD STARE BOXED CLEAR PINE RISERS W/ RED OAK TREADS FORMED CUSTOM RALING/SPINOLES TO REPLACE LOW DRYWALL WALL ABOVE PROV. 2 COATS CLE BASED POLYBETHING ALL EMPOSED SAREAGES.
- (NE. TO PROVIDE CUSTOM I/ 2" THK. (TEMPERED) SHOWER (2.ASS PANEL & DOOR WITH CUSTOM BRUSHED PRASS HANDLE AND HARDWAYE. (66" H.) ON 9" W. MARDLE SADDLE.
- UNITS TO BE MADE OF CLEAR FINE PAINTED W/ 3 COATS OF BEN MODE SEMI-CLOSS PAINT.
- CLOSET INTERIOR TO CONSIST OF 9 FIXED SHELVES ON RIGHT SHE (1) 2 CLOSET WORM). LEFT SIDE TO CONSIST OF CONT, FIXED COAT ROD & FIXED SHELF. LINIST OF B. MADE OF CLEAP FINE PAINTED W/ 9 COATS OF DEN. MOORE SEMI-02-OSS FAINT.
- PROV. CLISTOM E PD.M. SHOWER PAN ALL NEW SHOWERS
 PREPARE FOR NEW CERAMIC TILE (1191CA, ALL SHOWERS)
- PROV. POL. CHROME OH EXHAUST FAN TO BE DUCTED OUTSIDE ADJ. WALL. ALLOW \$1,200,00 FOR WIIT AND DUCTING, PROVIDE B" DIA EXHAUST VENT TO TO EXTERIOR WALL SOFFIT AREA (GALVANIZED & SCREENED)
- BF. 9" PROV. PULL-DOWN ATTIC ACCESS STAR, "BESSLER" OR APP. EO.
- PROVIDE PINE RISERS/ RUNS BASEMENT STAIR WITH FORMED HANDRAL. (SHIPS LADDER TO PIT FLOOR TO FLOOR HEIGHT-V.I.F.)
- PROVIDE ALLOWANCE FOR 36" H. X 36" W. CABINET W/ PLASTIC LAMINATE TOP B. SPACE FOR RECESSED KONLER VANITY SINX.



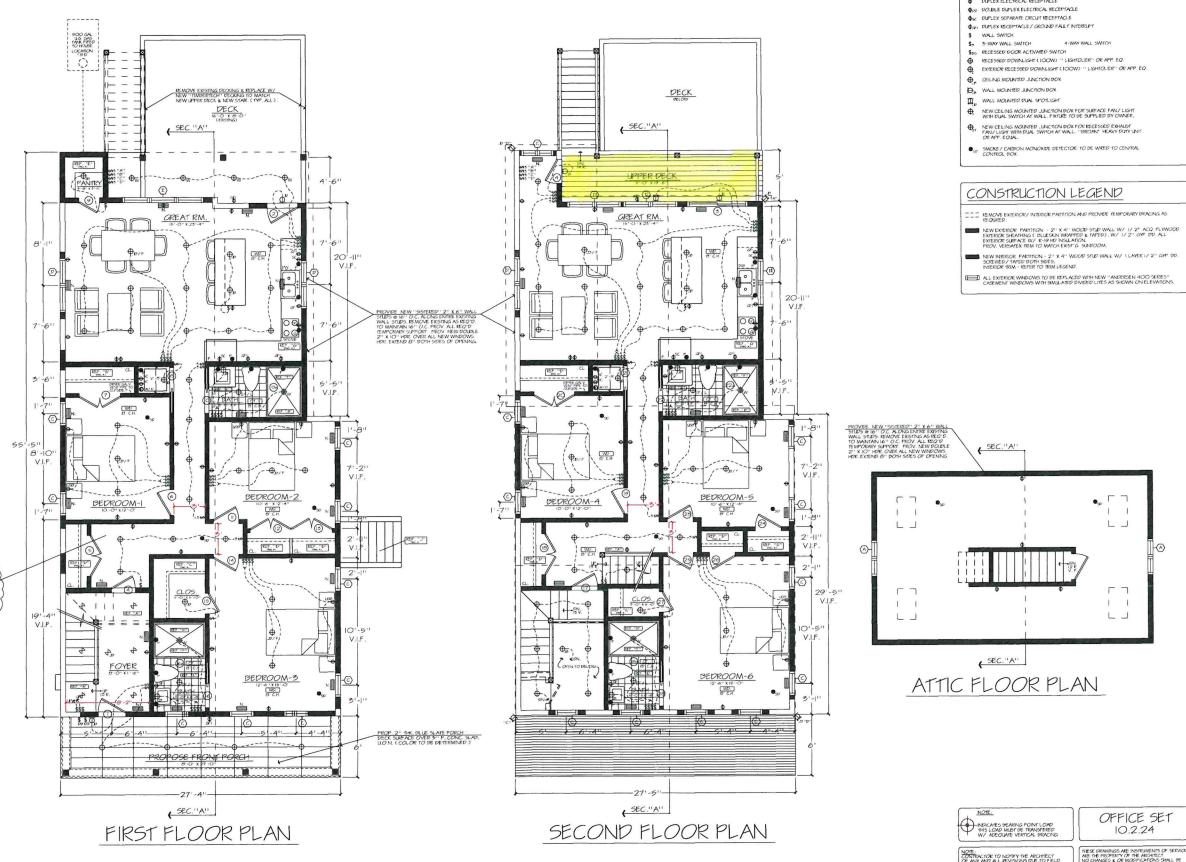

ELECTRICAL LEGEND

A DIPLEY FLECTRICAL RECEPTACLE

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OCH MCCULL PROPOSED ST./ MAIN <u>9</u> 1/4" = 1'-0"

DWG NAME: ROPOSEDS FIRST SECOND & ATTIC CONSTRUCTION FLOOR PLANS

DWG NO .: A-1