

ACCESSORY BUILDING

HISTORIC PRESERVATION COMMISSION REVIEW

APPLICATION FOR CERTIFICATE OF APPROPRIATENESS

PURSUANT TO THE PROVISIONS OF CHAPTER 48 HISTORIC PRESERVATION LAW OF THE VILLAGE OF GREENPORT

DATE OF APP	PLICATION:	
LOCATION OF	OF PROPERTY: 449 MAIN STREET, GREENPORT	
SUFFOLK CO	DUNTY TAX MAP NUMBER: 1001- 4-7-18	
PROPERTY O	OWNER: 449 MAIN STREET HOLDINGS LLC	
ADDRESS: 43	317 Begen Avenue, Mattituck, NY 11952 PHO	NE
EMAIL ADDRE		
ARCHITECT/D	DESIGNER: John Condon, PE	
ADDRESS: 175	755 Sigsbee Road, MATTITUCK PHOI	NE.
EMAIL ADDRE		
Typooft	Dyong J VVI	
Type of r	Proposed Work	
	☐ COMMERCIAL ☐ RESIDENTIAL	
Site Worl	-15-	
CILE TY OIL	.Th.	
x	FENCE DRIVEWAY, WALK, PATIO, OTHER PAVEMENT	
	MAJOR EXCAVATION OR REGRADING, OR BERM	
	SWIMMING POOL, TENNIS COURT OTHER STRUCTURAL LANDSCAPE ELEMENT	
(). *************	SIGNAGE- SUBMIT SCALE DRAWINGS TO INDICATING TO FO - SIZE OF EACH SIGN	LLOWING:
	- COLOR - FONT	
	- LOCATIONS OF ALL SIGNAGE ON BUILDING - PROPOSED MATERIALS	
	THO OSED WATERIALS	
Landscap	pe Planting	
	HEDGE ALONG STREET AND/OR PROPERTY BOUNDARY LIN	NEO
	PLANTINGS INTENDED TO SCREEN OTHER WORK DESCRIBE	ED IN THIS APPLICATION
Buildings	5	
×	NEW CONSTRUCTION	
<u>x</u>	ADDITION DEMOLITION	
	REMOVAL	

Duilding Alterations
Building Alterations
EXTERIOR WALL MATERIAL - board and battoen-HardiPlank Verticle siding ROOF MATERIAL AND COLOR 30 year asphalltic shingles CHIMNEY MATERIAL FOUNDATION MATERIAL DOORWAYS (INCLUDING STORM/SCREEN DOORS) WINDOWS (INCLUDING STORM/SCREEN SASH) PORCHES AND STEPS TRIM GUTTERS AND LEADERS PAINT AND STAIN OTHER
PROVIDE A GENERAL DESCRIPTION OF THE PROPOSED WORK (USE ADDITIONAL SHEETS IF NECESSARY, REFER TO THE
ACCOMPANYING EXHIBITS). Reconstruction and enlargement of an existing garage to create two accessory apartment units. First floor unit to be 534 sq. ft. 1 bedroom apartment and second floor is a 460 sq. ft. studio apartment.
IST ALL EVHIDITS SUBMITTED WITH THIS ADDITION (DEFED TO THE MOTDUSTIONS
IST ALL EXHIBITS SUBMITTED WITH THIS APPLICATION (REFER TO THE INSTRUCTIONS FOR THE REQUIRED SUBMISSIONS).
exhibits of siding, color, roofing and window specs will be provided at meeting for discussion
OTHER APPROVALS REQUIRED: SIGNATURE OF OWNER OR AUTHORIZED AGENT: DATE: 333161

Quiet Man Studio

Eileen: 516.818.9754 eileen@quietmanstudio.com

2805 West Mill Road Mattituck, New York

March 23, 2021

Village of Greenport Historic Preservation Commission

Re: 449 Main Street, Greenport, NY

The redevelopment of the existing accessory structure and addition is to be built of the following material:

Roof:

Timberline, Charcoal color architectural shingle

Siding:

James Hardy Board and Batten vertical siding,

Windows and door trim, soffit, and facia boards: White composite Versatex or Azek

Windows:

Andersen Window; a series, black exterior/white interior, Double hung windows to be 4/1, full divided light Casement windows: grills as shown, full divided light

Doors:


- 3-5' x 6'8" Andersen sliding glass doors
- 2- Entry doors 3'0" x 6'8" painted finish

Leaders and Gutters

Standard white aluminum

Rear Deck:

Cedar deck with natural wood handrail.

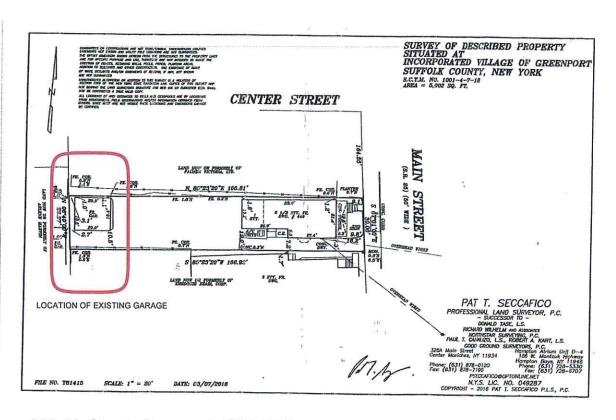

230 4th Street, Greenport, NY 11944

GENERAL NOTES:

1. ALL WORK MATERIAL AND EQUIPMENT SHALL BE IN ACCORDANCE WITH THE 2020 NEW YORK STATE UNIFORM BUILDING CODE, AND THE NEW YORK STATE ENERGY CONSERVATION CODE, AND LOCAL AUTHORITIES.

2. ALL CONCRETE SHALL BE STONE AGGREGATE WITH A MINIMUM 28 DAY STRENGTH OF 3000 PSI.

3. ALL LUMBER SHALL BE GRADE STAMPED DOUGLAS FIR-LARCH STRUCTURAL GRADE #2 OR BETTER.

4. PROVIDE DOUBLE HEADERS AND TRIMMERS AT ALL STAIR AND FLOOR OPENINGS, POSTS AND PARALLEL PARTITIONS, EXCEPT AS NOTED ON DRAWING.

5. BRIDGING TO BE PROVIDED FOR ALL JOISTS AND FLOOR BEAM. SPACING NOT TO EXCEED 8 FT.

6. ALL DIMENSIONS AND GRADE CONDITIONS TO BE VERIFIED BY CONTRACTOR(S) PRIOR TO START OF CONSTRUCTION AND ORDERING OF MATERIALS. THIS FOUNDATION HAS BEEN DESIGNED FOR A SOIL BEARING CAPACITY OF TWO (2) TSF AND GRADES LESS THAN 5% CONTRACTOR SHALL VERIFY THAT THESE CONDITIONS ARE MET. ALL FILL BENEATH CONCRETE SLABS TO BE COMPACTED TO 95% RELATIVE DENSITY.

7. DO NOT BACKFILL AGAINST FOUNDATION WALLS UNTIL FLOOR SYSTEM IS INSTALLED.

8. ALL HEADERS 6 FT IN LENGTH AND OVER TO BE SUPPORTED BY DOUBLE UPRIGHTS, 9 FT AND OVER BY TRIPLE UPRIGHTS, ALL HEADERS TO BE MINIMUM OF (2) 2x8* OR AS NOTED

9. PROVIDE FIRESTOPPING AT ALL LEVEL PENETRATIONS.

10. PROVIDE FLASHING AT ALL ROOF BREAKS, CHIMNEYS, SKYLIGHTS, EXTERIOR DOORS, WINDOWS, DECKS, ETC.

11. DO NOT SCALE DRAWINGS

12. DESIGN CONSULTANTS OR RECORD ARCHITECT-ENGINEER ARE NOT RESPONSIBLE FOR THE INSPECTION, SUPERVISION, OR ADMINISTRATION OF THIS CONSTRUCTION PROJECT. FEDERAL, STATE AND LOCAL ZONING AND BUILDING CODE COMPLIANCE SHALL BE THE RESPONSIBILITY OF THE CONTRACTOR(S).

13. DESIGNER, ARCHITECT, OR ENGINEER MUST BE NOTIFIED IN WRITING BEFORE ANY CHANGES ARE MADE TO PLANS.

14. ELECTRICAL AND MECHANICAL COMPONENTS TO BE DESIGNED AND SPECIFIED BY OTHERS.

15. CONTRACTOR SHALL OBTAIN ALL PERMITS AND INSURANCE NECESSARY TO PROTECT THE ENGINEER AND OWNER.

PATIO AND DECI
EXISTING 128 S.F.
PROPOSED 259 S.F.
TOTAL 337 S.F.

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DATE:				i	

JAN. 29, 2020

REVISIONS:

NOV. 20, 2020

DESIGN CRITERIA:

GROUND SNOW LOAD
LIVING AREAS AND DECKS
SLEEPING AREA
ATTIC
WIND SPEED
SEISMIC DESIGN CATEGORY
WEATHERING
FROST LINE DEPTH
TERMITE
DECAY
ICE SHEILD REQ.

LIVE LOAD DEAD LOAD

25 PSF. 15 PSF.
40 PSF. 15 PSF.
30 PSF. 15 PSF.
140MPH
B
SEVERE
36"
MOD. - HVY.
SLIGHT
YES


APPLICATION FOR BUILDING PERMIT CONVERSION OF EXISTING GARAGE AND ADDITION



NOTE

TOTAL LOT COVERAGE = 38.5%

PATIO AND DECK (387 S.F.) + BUILDINGS (1,536 S.F.) / TOTAL LOT (4,991 S.F.)

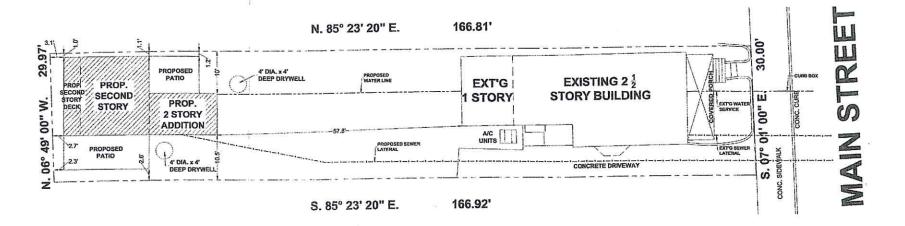

SITE PLAN


PROPERTY LOCATED AT:
449 MAIN STREET GREENPORT, NY 11944
VILLAGE OF GREENPORT, TOWN OF SOUTHOLD
COUNTY OF SUFFOLK, STATE OF NEW YORK
DISTRICT: 1001 SECTION: 4 BLOCK: 7 LOT: 18

SITE PLAN BASED ON INFORMATION FROM THE SURVEY DONE BY: PAT. T. SECCAFICO PROFESSIONAL LAND SURVEYORS, P.C. DATED: MAR. 7, 2016




449 MAIN HOLDINGS LLC 449 MAIN STREET GREENPORT, NY 11944 Condon Engineering, P.C. 1755 Sigsbee Road Mattituck, NY 11952


1" = 10'-0" DWG. NO. 100.01

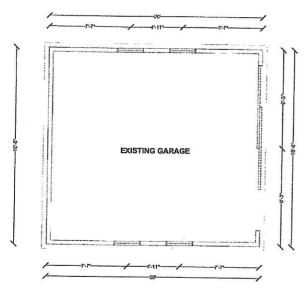


EXISTING FLOOR PLAN

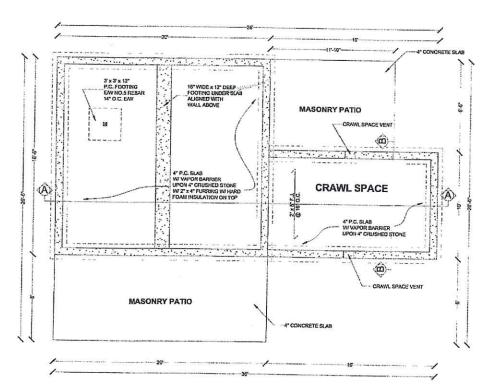


PROPOSED FOUNDATION PLAN

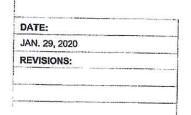

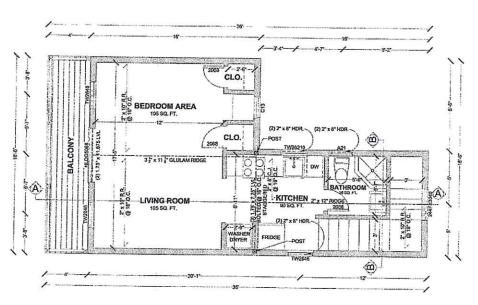


PROPOSED SECOND FLOOR PLAN

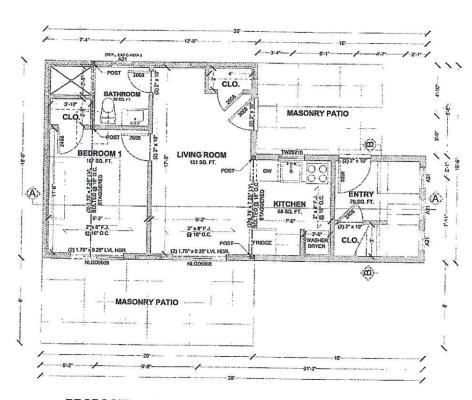

PROPOSED FIRST FLOOR PLAN

LEGEND

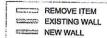

10 - Follow cold weather concrete treatment relative to add mixtures in accordance with ACI 212.3R. Use Air-Entraining admixtures per ASTM C280, AASHTO M154 or Water Reducing and Set-Controlling Admixtures per ASTM C494, AASHTO M194 only. Do not uso Calcium Chloride or other cornosive type


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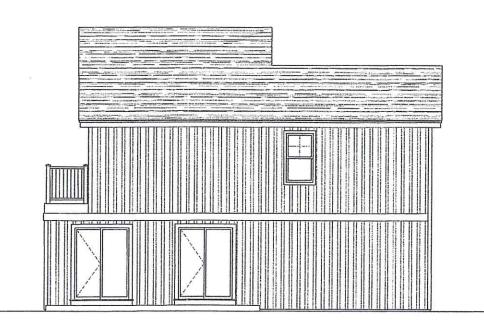
SCALE: " \frac{1}{4}" = 1'-0"

DWG. NO. 300.01


449 MAIN HOLDINGS LLC 449 MAIN STREET GREENPORT, NY 11944



PROPOSED NORTH ELEVATION

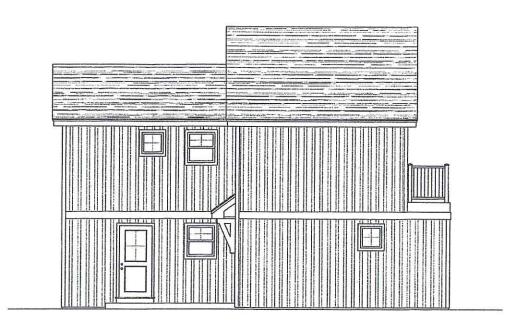


PROPOSED SOUTH ELEVATION

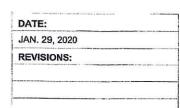



PROPOSED FRONT ELEVATION



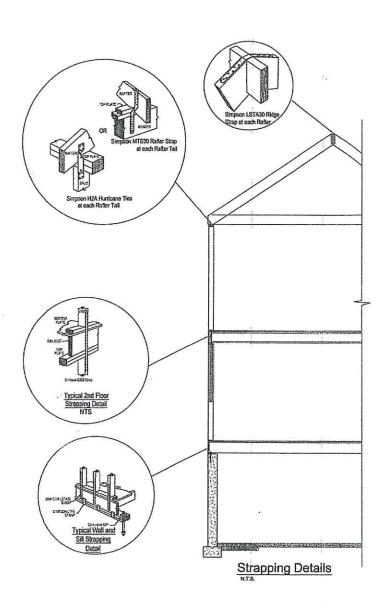


PROPOSED REAR ELEVATION


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SCALE: 1₄" = 1'-0" DWG. NO.

400.01

449 MAIN HOLDINGS LLC 449 MAIN STREET GREENPORT, NY 11944



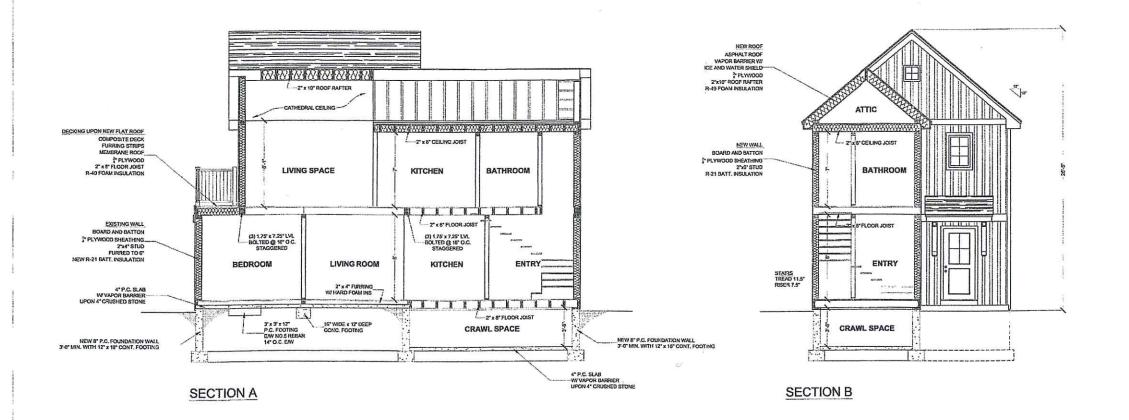

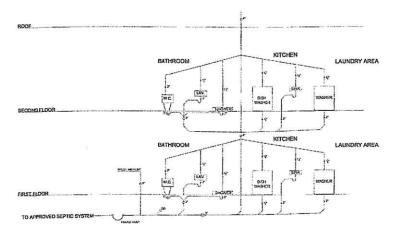UNIT	QTY.	BRAND	MAN. CODE	SIZE	TYPE	NOTES
A	1	ANDERSEN	244FX3040	3040	PICTURE	FULL DIVIDED GRILL
В	1	ANDERSEN	C13	2030	CASEMENT	FULL DIVIDED GRILL
C	3	ANDERSEN	244FX1816	1816	TRANSOM	FULL DIVIDED GRILL
D	5	ANDERSEN	A21	2020	AWNING	FULL DIVIDED GRILL, TEMPERED
E	2	ANDERSEN	TW26210	26210	DBL. HUNG	FULL DIVIDED GRILL
F	1	ANDERSEN	TW2646	2645	DBL. HUNG	FULL DIVIDED GRILL, TEMPERED
G	2	ANDERSEN	TW2646	2646	DBL, HUNG	FULL DIVIDED GRILL
H	3	ANDERSEN	NLGD5068	5063	SLIDING DOOR	NO GRILL
1	2	N/A	3068	3068	EXT. DOOR	STYLE DECIDED BY OWNER
J	5	N/A	2068	2068	INT, DOOR	STYLE DECIDED BY OWNER
K	2	N/A	2468	2468	INT, DOOR	STYLE DECIDED BY OWNER
L	1	N/A	2668	2663	INT. DOOR	STYLE DECIDED BY OWNER

DATE:
JAN. 29, 2020
REVISIONS:

449 MAIN HOLDINGS LLC
449 MAIN STREET GREENPORT, NY 11944

Framing Notes:

The contractor is to verify all measurements in the field and any discrepancies are be brought to the attention of the Engineer prior to construction.

Nood Framing

All tumber is to be No. 2 or better Dougles Fir Larch (N) with the following minimus specifications:

Fb = 825 psi Fv = 95 psi Fc perp = 625 psi E = 1,600,000 psi

2. All Parallam (PSL) Lumber is to have the following minimum specification:

Fb = 2,900 psi Fv = 290 psi Fc perp = 750 psi E = 2,000,000 psi

All Microllam (LVL) Lumber is to have the following minimum specifications:

Fb = 2,600 psi Fv = 285 psi Fc perp = 750 psi E = 1,900,000 psi

 All Glued Laminated Beams (GLB) aka Anthony Power Beam are to have the following minimum specifications:

> Fb = 3,000 psi Fv = 300 psi Fc perp = 805 psi F = 2,100 000 psi

- All beams fabricated with multiple Laminated Veneer Lumber boards are to be nailed/hotted in accordance with the manufacturer's specifications.
- All TJIs are to be installed in accordance with the manufacturer's specifications and shall include squash blocking and web stiffeners at bearing points on girders and other load bearing areas.
- 7. All straps, connectors, plates, botts, nails, etc. are to be galvanized or stainless steel. Designated connectors, strap etc. on these drowings are made by Simpson unless indicated otherwise. All connectors, straps etc. are to be nailed/botted in accordance with the manufacturer's specifications.
- All floor shealthing is to be ²½ Inch AC type plywood, tongue and groove, with an APA span rating of 48/24. Floor shealthing shall be glued and screwed to the floor joists (6" O.C. edges and 12 " O.C. floid).
- All wall sheathing is to be 15/32 inch APA Rated Exposure 1 plywood and shall be neiled with 10d common nails 6* O.C. edges and 12* O.C. field;
- Solid blocking is to be installed every 8" max or mid span of all floor joists with spans exceeding 8".
- Double joists are to be installed below parallel walls
- 12. Blocking is to be installed at all point load bearing points.
- Wa'ls are to be framed with 2x6 inch studs spaced 16 inches OC unless indicated otherwise.
- 14. All boils nuts and washers are to be hot dipped galvanized.

Steel Notes:

- All sleet is to be ASTM Specification A-992-50
- All Tube Steel ASTM A500-GR-46
- All boiled connections are to be made with A-325 b
- All welded connections are to be done by a certified welder and conform to AWS and AISC standards.
- All weld joints are to use E70XX electrode
- Steel is to be cleaned and shop prime with one coat TNEMEC 37-77 W Chem Prime at 2.0 - 3.0 MDF.
- ½" web stiffeners are to be installed at all point load bearing points and over all column supports.
- All columns are to be botted to steel girders with ½° boils and to wood girde with ½° lag boils.
- All girder splices are to be made above columns.



Condon Engineering, P.C. 1755 Sigsbee Road Mattituck, NY 11952

SCALE: ¹" = 1'-0"

DWG. NO. 400.02