

# ZONING BOARD OF APPEALS APPLICATION AREA VARIANCE

236 Third Street, Greenport, New York, 11944 (631) 477-0248 www.villageofgreenport.org

Date of Application \_\_\_\_\_

All information below is to be completed by the applicant. This completed application is to be accompanied by the Notice of Disapproval, Copies of Covenants and/or Restrictions, where applicable, Environmental Assessment Form, building plans showing elevations, setbacks, floor plans, room dimensions, details of footings and foundation, and species of lumber and quality of material, where applicable.

of material, where applic	able.	5	and speci	es of fumber and quali
THE OWNER OF	THE PROPERT	Y IS: (PLEASE PRINT C	LEARLY)	
Jenna and Donald V	Villiams			
First Name	Last Name	(4)	*	
	Last Ivaine		Business Name, if a	pplicable
A THE RESIDENCE OF THE		C Applied 2		
Mailing Address		City/ Town/ Village		
		City/ Town/ Village	State	Zip
	4		The second second	
Phone #		E-Mail Address		
CONTACT PERSO	N (if different from	owner)		
The person to receive a	ll correspondence:			
Isaac Clay	Coffey	Ĭcar	ac-Rae Studio	
First Name	Last Name			
11575 Main Day			Business Name, if ap	plicable
11575 Main Bayvie	w Road	Southold NY		11971
Mailing Address		City/ Town/ Village	G	
-			State	Zip
347-276-6093 Phone #		clay@isaac-rae.com		
rnone #		E-Mail Address		
IF ANYONE OTHER	THAN THE OWNE	R COMPLETES THIS APP	I ICATION INDEED	
FROM THE OWNER	MUST BE SUBMIT	TED WITH THIS APPLICA	LICATION, WRITTE. ATION	N CONSENT
Location:			111011.	
Location:				
Suffolk County Tax	Map Number: 10	001 Section: _4 E	Block: 3 Lot	32
Street Address:			enport, New York,	
Zoning District: [ ] Is property located	WC []R1 [¾R: within the Histo	2 [] PD [] CR [] CG ric District? [¾ Yes []		



## ZONING BOARD OF APPEALS APPLICATION AREA VARIANCE

AREA VARIANCE

236 Third Street, Greenport, New York, 11944
(631) 477-0248

www.villageofgreenport.org

The Code Official reviewed and denied an application dated January 12, 2021 for a Building Permit for the location specified on this application.
Provisions of the Zoning Code appealed: (Indicate Article, Section and Subsection of Zoning Code by numbers)
Article: Section: 150 12 Subsection:
Type of appeal made for:  [x] A Variance to the Zoning Code or Zoning Map.  [ ] An interpretation of the Village Code Article: Section: Subsection:
Has a prior appeal been made at any time with respect to this property? [¾ Yes [] No [] I Don't Know If yes, please provide the date appeal was made:March 31, 1983
Project Description:
For Demolition of Existing Building Areas: Please describe area being removed:
Construction will remove the deteriorating existing back deck and exterior stairs. A portion of an exterior wall will be removed to connect primary structure with accessory structure.
New Construction Areas (New Dwelling or New Addition/Extensions)
Dimensions of First Floor (Addition/Extension): 20sqft ground floor extension to connect buildings
Dimensions of Second Floor Addition/Extension): 175 sqft 2nd floor deck
Height (from finished grade to top of ridge): 38 - Feet, 0 - Inches
Is basement or lowest floor area being constructed? [] Yes [] No  If yes, please provide height (above ground) measured from natural existing grade to first floor:  Feet, Inches.



# ZONING BOARD OF APPEALS APPLICATION AREA VARIANCE

236 Third Street, Greenport, New York, 11944 (631) 477-0248 www.villageofgreenport.org

Project Description: (CONTINUED)
Proposed Construction Description: (Alteration or Structural Changes)
Number of floors BEFORE alterations: 2.5
Describe General Characteristics BEFORE alterations:
A pre-existing non-conforming 2.5-story 5,503sq ft building and a pre-existing non-conforming 4791.6 sq ft accessory structure located in the front and side yards.
Number of floors AFTER Alterations: 2.5
Describe General Characteristics AFTER alterations:
A 2.5 story 5,523 sq ft building that incorporates existing accessory structure and constructs habitable living space including (4) bedrooms and (1) bath on the existing ground floor and creates (1) bath and (1) bedroom as on the existing the 2.5 floor.
Calculations of Building Areas and Lot Coverage:
Existing Square Footage of Building(s) on this property: 2,505 GROUND FLOOR SF
Proposed Increase in Building Coverage:SF
Square Footage of this Lot: 4791.6 SF
Percentage of Coverage of this Lot by Building Area:%
Purpose of New Construction:  Please describe:  Renovation for a single family to convert existing non-conforming 2.5 story building and accessory structure into a contiguous single family residence consisting of a existing 2505 sq habitable ground floor with an existing 1870.
consisting of a existing 2505 sq habitable ground floor, with an existing 1870 sq second floor residential space and proposed conversion of existing 998s building.

Ground floor renovation will include (4) new bedrooms and (1) new bath. Renovation will also update the 2.5 level to be a code compliant habitable living space consisting of (1) new bedroom and (1) new bathroom. Construction will also include installing a code-compliant sprinkler system. Construction will also rebuild and reduce the size of deteriorating existing back deck and exterior stairs. Proposed rebuilt deck will be 175 sq ft.

The renovation proposes a newly built 20 sq ft ground floor extension to connect the existing accessory structure with the existing ground floor. The extension is enclosed and part of the thermal envelope of the building. This will bring the ground floor habitable square footage to 2525 sq ft.



## ZONING BOARD OF APPEALS APPLICATION

## AREA VARIANCE

236 Third Street, Greenport, New York, 11944 (631) 477-0248 www.villageofgreenport.org

## Area Variance Reasons for Appeal:

Please answer in detail. Additional sheets may be submitted with preparers signature.

Will an undesirable change occur in the characteristics of the neighborhood or will a detriment to nearby properties be created by the granting of this area variance?

The requested area variances regarding Section 150-12 will not impact the characteristics of the neighborhood nor will it be a detriment to neighboring properties. The area variances will address the pre-existing non-conforming site of the one-family dwelling. The area variances being requested regarding Section 150-12 pertain only to the 2.5 single family dwelling and are as follows: (1) to address building height requirements that have been cited by stating that the 2.5 floor level will not in any way increase the building height or roofline. This project will only convert the existing footprint of the 2.5 level into legally habitable space; (2) to allow a 22% lot coverage increase; (3)to allow an additional 29st 6in to the front yard setback; (4)allow an additional 8st6in to the side yard setback; (5) allow an additional 13ft9.5in combined yard setback, please note that the single-family dwelling meets the southside side yard setback, but does not meet the northside side yard setback; (6) allow an additional 22ft7.5in to the rear yard setback.

Can the benefit sought by the Applicant be achieved by another method, feasible for the Applicant to

pursue, other than an Area Variance?

No, there is no other way to achieve the benefit that is sought by the homeowners other than requesting area variances that recognize the pre-existing non-conforming aspects of this property.

## Is the requested Area Variance substantial?

The area variances requested pertaining to Section 150-12 of district regulations are as follows:

(1) to address building height requirements that have been cited by stating that the 2.5 floor level will not in any way increase the building height or roofline. This project will only convert the existing footprint of the 2.5 level into legally habitable space; (2) to allow a 22% lot coverage increase; (3)to allow an additional 29ft 6in to the front yard setback; (4)allow an additional 8ft6in to the side yard setback; (5) allow an additional 13ft9.5in combined yard setback, please note that the single-family dwelling meets the southside side yard setback, but does not meet the northside side yard setback; (6) allow an additional 22ft7.5in to the rear yard setback.

Will the requested Area Variance have an adverse effect or impact on the physical or environmental conditions in the neighborhood or district?

No, there will be no physical or environmental impact to the neighborhood or district by granting these area variances. They merely will recognize the pre-existing non-conforming site of this property.

Was the alleged difficulty self-created, which consideration shall be relevant to the decision of the Zoning Board of Appeals, but shall not necessarily preclude the granting of the Area Variance?

No, the current homeowners inherited the pre-existing non-conforming aspects of this one-family dwelling/2.5 story building and accessory structure and wish to bring this property up to village compliant standards.

Are there Covenants or Restrictions concerning this land? [] Yes [] No If yes, please furnish copies.



## Village of Greenport Building Department

236 Third Street, Greenport, New York 11944 OFFICE: 631.477.0248 / FAX: 631.477.1877

## AMENDED NOTICE OF DISAPPROVAL

Date:

March 4, 2021

To:

Donald Williams

511 Carpenter Street

Greenport, New York 11944

PLEASE TAKE NOTICE that your application dated December 24, 2020 – with required documents received on January 7, 2021 - to make alterations to a 2-story building and an accessory structure at 511 Carpenter Street - is returned herewith and disapproved on the following grounds:

## 1. Building Height Requirements.

## 150-12 District Regulations

One-Family dwelling: Max. Height: 35' OR 2 1/2 Stories. (R-2)

The plans show a proposed third floor addition. This would require an area variance for a third story.

## 2. Lot Coverage Requirements.

## 150-12 District Regulations

One-Family dwelling: Max. lot coverage: 30% (R-2)

The specifications show the proposed lot coverage is 2,525 SF (52%). The allowable lot coverage is 1,437 SF (30%) This would require an area variance of 1,088 SF (22%) lot coverage increase.

## 3. Front Yard Setback Requirements.

## 150-12 District Regulations

One-Family dwelling: Front Yard Setback: 30-feet. (R-2)

The plans show the front yard of the 2-story building setback of 1-feet, 6-inches. This would require an area variance of 28-feet, 6-inches.

Page 1 of 2

## 4. Side Yard Setback Requirements.

## 150-12 District Regulations

One-Family dwelling: Side Yard Setback: 10-feet. (R-2)

The plans show the front yard setback of 1-feet, 6-inches. This would require an area variance of 8-feet, 6-inches.

## 5. Combined Yard Setback Requirements.

## 150-12 District Regulations

One-Family dwelling: Combined Yard Setbacks: 25-feet. (R-2)

The plans show the front yard setback of 1-feet, 6-inches on the north side. And 3-feet, 4-inches on the south side. this would require an area variance of 20-feet, 4-inches.

## 6. Rear Yard Setback Requirements.

## 150-12 District Regulations

One-Family dwelling: Rear Yard Setback: 30-feet. (R-2)

The plans show the front yard setback of 5-feet, 6-inches. This would require an area variance of 24-feet, 6-inches.

This application is therefore denied, requiring the above-mentioned use variances and area variances.

Additionally, this project will have to obtain a Certificate of Appropriateness from the Historic Preservation Commission prior the issuance of Building Permit.

The premise to which this application applies to is located at: 511 Carpenter Street, Greenport, New York 11944.

This property is located in the R-2 District. This Property is located in the Historic District.

Map: 1001 Section: 4 Block: 3 Lot(s): 32

3/4/2021

Sreg Morris - NYS Code Enforcement Official Date

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## 617.20 Appendix B Short Environmental Assessment Form

## Instructions for Completing

Part 1 - Project Information. The applicant or project sponsor is responsible for the completion of Part 1. Responses become part of the application for approval or funding, are subject to public review, and may be subject to further verification. Complete Part 1 based on information currently available. If additional research or investigation would be needed to fully respond to any item, please answer as thoroughly as possible based on current information.

Complete all items in Part 1. You may also provide any additional information which you believe will be needed by or useful to the lead agency; attach additional pages as necessary to supplement any item.

Part I Pusint 10 Y C					
Part 1 - Project and Sponsor Information					
Name of Action or Project:					_
511 Carpenter Street					
Project Location (describe, and attach a location map):					
511 Carpenter Street, Greenport NY					
Brief Description of Proposed Action: Renovation for a single family to convert existing non-conforming 2.5 story building and access consisting of a existing 2505 sq habitable ground floor, with an existing 1870 sq second floor of t 2.5 level loft into a legally habitable third floor without expanding existing footprint of 2.5 l. The renovation proposes a newly built 20 sq ft ground floor extension to connect the existing extension is enclosed and part of the thermal envelope of the building. This will bring the ground floor renovation will include (4) new bedrooms and (1) new bath. Renovation will also space consisting of (1) new bedroom and (1) new bathroom. Construction will also include in will also rebuild and reduce the size of deteriorating existing back deck and exterior stairs. Pro	residential level loft o accessory und floor so update	space and proposed conve or changing the existing roo structure with the existing habitable square footage to the 2.5 level to be a code co	rsion of ex f line of the ground flo 2525 sq ft.	isting 998 s building. or. The	•
Name of Applicant or Sponsor:	Teleph	none: 646-275-244	17		
Isaac Clay Coffey, Margot Coffey	E-Mai	l: margot@isaac-1	rae.com	L	
Address: 11575 Main Bayview Road					
City/PO: Southold	141	State: NY	Zip Cod 1197		
1. Does the proposed action only involve the legislative adoption of a plan, le	ocal law	, ordinance,	NO	YES	3
administrative rule, or regulation?  If Yes, attach a narrative description of the intent of the proposed action and	the envi		.   _		
may be affected in the municipality and proceed to Part 2. If no, continue to	question	n 2.	nat   L	x	
2. Does the proposed action require a permit, approval or funding from any	other go	vernmental Agency?	NO	YES	3
If Yes, list agency(s) name and permit or approval: Building Department					
Historical Review Board			1	x	
	11	acres			-
b. Total acreage to be physically disturbed?	NA	acres			
c. Total acreage (project site and any contiguous properties) owned or controlled by the applicant or project sponsor?	.11	_acres			
4. Check all land uses that occur on, adjoining and near the proposed action.  ☐ Urban ☐ Rural (non-agriculture) ☐ Industrial ☐ Commo ☐ Forest ☐ Agriculture ☐ Aquatic ☐ Other (☐ Parkland	ercial	XResidential (suburb	an)	<b>-</b> 8	

Page 1 of 4

5. Is the proposed action,	YES	N/A
a. A permitted use under the zoning regulations?	IX	
b. Consistent with the adopted comprehensive plan?	X	H
6. Is the proposed action consistent with the predominant character of the existing built or natural	NO	YES
landscape?	Ï	x
7. Is the site of the proposed action located in, or does it adjoin, a state listed Critical Environmental Area?	NO	YES
If Yes, identify:	x	
8. a. Will the proposed action result in a substantial increase in traffic above present levels?	NO	YES
This is single family residence, the homeowners currently live here full time and park 2 cars on the stree		LES
b. Are public transportation service(s) available at or near the site of the proposed action?	t. x	片
c. Are any pedestrian accommodations or bicycle routes available on or near site of the proposed action?	片	x
Does the proposed action meet or exceed the state energy code requirements?	NO	YES
If the proposed action will exceed requirements, describe design features and technologies:		
		x
10. Will the proposed action connect to an existing public/private water supply?	NO	YES
If No, describe method for providing potable water:		
		X
11. Will the proposed action connect to existing wastewater utilities?	NO	YES
If No, describe method for providing wastewater treatment:		
,		x
12. a. Does the site contain a structure that is listed on either the State or National Register of Historic	NO	YES
Places?	x	П
b. Is the proposed action located in an archeological sensitive area?	x	H
13. a. Does any portion of the site of the proposed action, or lands adjoining the proposed action, contain	NO	YES
13. a. Does any portion of the site of the proposed action, or lands adjoining the proposed action, contain wetlands or other waterbodies regulated by a federal, state or local agency?	NO	YES
wetlands or other waterbodies regulated by a federal, state or local agency?  b. Would the proposed action physically alter, or encroach into, any existing wetland or waterbody?	NO x	YES
<ul> <li>13. a. Does any portion of the site of the proposed action, or lands adjoining the proposed action, contain wetlands or other waterbodies regulated by a federal, state or local agency?</li> <li>b. Would the proposed action physically alter, or encroach into, any existing wetland or waterbody?</li> <li>If Yes, identify the wetland or waterbody and extent of alterations in square feet or acres:</li> </ul>	NO	YES
wetlands or other waterbodies regulated by a federal, state or local agency?  b. Would the proposed action physically alter, or encroach into, any existing wetland or waterbody?	NO x	YES
wetlands or other waterbodies regulated by a federal, state or local agency?  b. Would the proposed action physically alter, or encroach into, any existing wetland or waterbody?  If Yes, identify the wetland or waterbody and extent of alterations in square feet or acres:	NO X	YES
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wetlands or other waterbodies regulated by a federal, state or local agency?  b. Would the proposed action physically alter, or encroach into, any existing wetland or waterbody?  If Yes, identify the wetland or waterbody and extent of alterations in square feet or acres:  14. Identify the typical habitat types that occur on, or are likely to be found on the project site. Check all that  Shoreline  Forest  Agricultural/grasslands  Early mid-successional  Wetland  Urban  Suburban	NO x x	YES
wetlands or other waterbodies regulated by a federal, state or local agency?  b. Would the proposed action physically alter, or encroach into, any existing wetland or waterbody?  If Yes, identify the wetland or waterbody and extent of alterations in square feet or acres:  14. Identify the typical habitat types that occur on, or are likely to be found on the project site. Check all that  Shoreline Forest Agricultural/grasslands Early mid-successional  Wetland Urban Suburban  15. Does the site of the proposed action contain any species of animal, or associated habitats, listed	NO X	YES
wetlands or other waterbodies regulated by a federal, state or local agency?  b. Would the proposed action physically alter, or encroach into, any existing wetland or waterbody?  If Yes, identify the wetland or waterbody and extent of alterations in square feet or acres:  14. Identify the typical habitat types that occur on, or are likely to be found on the project site. Check all that  Shoreline Forest Agricultural/grasslands Early mid-successional Wetland Urban Suburban  15. Does the site of the proposed action contain any species of animal, or associated habitats, listed by the State or Federal government as threatened or endangered?	NO x x	
wetlands or other waterbodies regulated by a federal, state or local agency?  b. Would the proposed action physically alter, or encroach into, any existing wetland or waterbody?  If Yes, identify the wetland or waterbody and extent of alterations in square feet or acres:  14. Identify the typical habitat types that occur on, or are likely to be found on the project site. Check all that  Shoreline Forest Agricultural/grasslands Early mid-successional  Wetland Urban Suburban  15. Does the site of the proposed action contain any species of animal, or associated habitats, listed	NO X X Apply:	
b. Would the proposed action physically alter, or encroach into, any existing wetland or waterbody?  If Yes, identify the wetland or waterbody and extent of alterations in square feet or acres:  14. Identify the typical habitat types that occur on, or are likely to be found on the project site. Check all that Shoreline Forest Agricultural/grasslands Early mid-successional Wetland Urban Suburban  15. Does the site of the proposed action contain any species of animal, or associated habitats, listed by the State or Federal government as threatened or endangered?  16. Is the project site located in the 100 year flood plain?	NO X apply:	YES
b. Would the proposed action physically alter, or encroach into, any existing wetland or waterbody?  If Yes, identify the wetland or waterbody and extent of alterations in square feet or acres:  14. Identify the typical habitat types that occur on, or are likely to be found on the project site. Check all that Shoreline Forest Agricultural/grasslands Early mid-successional Wetland Urban Suburban  15. Does the site of the proposed action contain any species of animal, or associated habitats, listed by the State or Federal government as threatened or endangered?  16. Is the project site located in the 100 year flood plain?	NO X apply:	YES
b. Would the proposed action physically alter, or encroach into, any existing wetland or waterbody?  If Yes, identify the wetland or waterbody and extent of alterations in square feet or acres:  14. Identify the typical habitat types that occur on, or are likely to be found on the project site. Check all that Shoreline Forest Agricultural/grasslands Early mid-successional Wetland Urban Suburban  15. Does the site of the proposed action contain any species of animal, or associated habitats, listed by the State or Federal government as threatened or endangered?  16. Is the project site located in the 100 year flood plain?	NO X NO X NO X	YES
b. Would the proposed action physically alter, or encroach into, any existing wetland or waterbody?  If Yes, identify the wetland or waterbody and extent of alterations in square feet or acres:  14. Identify the typical habitat types that occur on, or are likely to be found on the project site. Check all that Shoreline Forest Agricultural/grasslands Early mid-successional Wetland Urban Suburban  15. Does the site of the proposed action contain any species of animal, or associated habitats, listed by the State or Federal government as threatened or endangered?  16. Is the project site located in the 100 year flood plain?  17. Will the proposed action create storm water discharge, either from point or non-point sources? If Yes,  a. Will storm water discharges flow to adjacent properties?    X NO   YES	NO X NO X NO X	YES YES YES
b. Would the proposed action physically alter, or encroach into, any existing wetland or waterbody?  If Yes, identify the wetland or waterbody and extent of alterations in square feet or acres:  14. Identify the typical habitat types that occur on, or are likely to be found on the project site. Check all that Shoreline Forest Agricultural/grasslands Early mid-successional Wetland Urban Suburban  15. Does the site of the proposed action contain any species of animal, or associated habitats, listed by the State or Federal government as threatened or endangered?  16. Is the project site located in the 100 year flood plain?  17. Will the proposed action create storm water discharge, either from point or non-point sources?	NO X NO X NO X	YES YES YES

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18. Does the proposed action include construction or other activities that result in the impoundme water or other liquids (e.g. retention pond, waste lagoon, dam)?		NO	YE
f Yes, explain purpose and size:			
		x	
9. Has the site of the proposed action or an adjoining property been the location of an active or c	losed	NO	YES
solid waste management facility?		110	1 150
f Yes, describe:			ļ
		х	L
20. Has the site of the proposed action or an adjoining property been the subject of remediation (o	ngoing or	NO	YES
completed for nazardous waster			
f Yes, describe:		x	
		التا	Ь
AFFIRM THAT THE INFORMATION PROVIDED ABOVE IS TRUE AND ACCURATE			
NOWLEDGE	E TO THE E	BEST O	FMY
applicant/sponsor name: Clay Coffey, RA	24		
Date. Of 172	27		
ignature: Clay Coffey			
	No, or small	to l	lerate arge
	impact		pact
	may occur		ay cur
Will the proposed action create a material conflict with an adopted land use plan or zoning	occur	00	cur
regulations?			
Will the proposed action result in a change in the use or intensity of use of land?		+	=
Will the proposed action impair the character or quality of the existing community?		<del>                                     </del>	=
Will the proposed action have an impact on the environmental characteristics that caused the		T-	
establishment of a Critical Environmental Area (CEA)?		L	
Will the proposed action result in an adverse change in the existing level of traffic or		+-	
affect existing infrastructure for mass transit, biking or walkway?			
Will the proposed action cause an increase in the use of energy and it fails to incorporate		1-	
reasonably available energy conservation or renewable energy opportunities?			
Will the proposed action impact existing:	+=	<u> </u>	
a. public / private water supplies?			
2 2 2 2 2 2 2 2 2 2 2 2 2 2 2 2 2 2 2 2			=
b. public / private wastewater treatment utilities?			
Will the proposed action impair the character or quality of important historic, archaeological,		F	=
architectural or aesthetic resources?		L	
Will the proposed action result in an adverse change to natural resources (e.g., wetlands,		1	
waterbodies, groundwater, air quality, flora and fauna)?	1 1 1		- 1

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MAR 1 3 2021

	No, or small impact may occur	Moderate to large impact may occur	THE PARTY AND PROPERTY.
10. Will the proposed action result in an increase in the potential for erosion, flooding or drainage problems?			
11. Will the proposed action create a hazard to environmental resources or human health?	TIT		

Part 3 - Determination of significance. The Lead Agency is responsible for the completion of Part 3. For every question in Part 2 that was answered "moderate to large impact may occur", or if there is a need to explain why a particular element of the proposed action may or will not result in a significant adverse environmental impact, please complete Part 3. Part 3 should, in sufficient detail, identify the impact, including any measures or design elements that have been included by the project sponsor to avoid or reduce impacts. Part 3 should also explain how the lead agency determined that the impact may or will not be significant. Each potential impact should be assessed considering its setting, probability of occurring, duration, irreversibility, geographic scope and magnitude. Also consider the potential for short-term, long-term and cumulative impacts.

that the proposed action may result in one or more pot environmental impact statement is required.	ormation and analysis above, and any supporting documentation
Name of Lead Agency	Date .
Print or Type Name of Responsible Officer in Lead Agency	Title of Responsible Officer
Signature of Responsible Officer in Lead Agency	Signature of Preparer (if different from Responsible Officer)


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## 511 CARPENTER STREET **GREENPORT NY 11939** NY 11944, SCTM#: 1001-04-03-32

ZONING INFORMATION

COUNTY	SUFFOLK				
TAX MAP NUMBER	1001-04-03-32				
VILLAGE	GREENPORT				
BLOCK	3				
LOT	26.3				
NUMBER OF FLOORS	3				
LOT AREA	.11 ACRES OR 4791.6 SQFT				
ALLOABLE BUILDING COVERAGE	1,437 OR 30%				
EXISTING ROOFED BUILDING COVERAGE	2,505 OR 52%				
PROPOSED ROOFED BUILDING COVERAGE	2,525 OR 52%				
ZONING	R-2				
ZONING MAP	GREENPORT VILLAGE				
LANDMARK DESIGNATION	NONE				
HISTORIC DISTRICT	YES				
BUILDING HEIGHT	38 FT				
CONSTRUCTION CLASSIFICATION	VB- CONBUSTIBLE				
OCCUPANCY USE GROUP	RESIDENTIAL R-2				
ACCESSORY OCCUPANCY USE GROUP	( <del>5</del> 5)				
SPRINKERS SYSTEM	PARTIALLY SPRINKLERED (PROPOSED)				



#### LOCATION MAP NOT TO SCALE
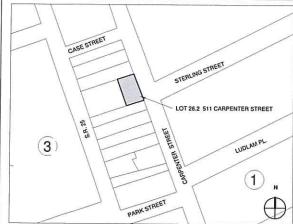
#### SCOPE OF WORK PROPOSED IN THIS FILING:

INTERIOR ALTERATIONS TO INCLUDE THE REMOVAL OF THE FOLLOWING:

- REMOVAL OF EXISTING NON LOAD BEARING INTERIOR WALLS
- REMOVAL OF EXISTING PLUMBING FIXTURES REMOVAL OF PORTION OF STORAGE LOFT FLOOR

### INTERIOR ALTERATIONS TO INCLUDE THE FOLLOWING:

- NEW PROPOSED INTERIOR NON LOAD BEARING WALLS NEW PROPOSED PLUMBING FIXTURES AND IN EXISTING AND NEW LOCATIONS
- NEW PROPOSED ELECTRICAL FIXTURES AND LOCATIONS
  NEW PROPOSED FIXED PANED WINDOW TO REPLACE EXISTING SLIDING
- DOORS ON 2ND FLOOR
- CONVERSION OF EXISTING ATTIC LOFT INTO HABITABLE 3RD FLOOR PROPOSED EGRESS STAIR TO PROPOSED 3RD FLOOR
- PROPOSED CONCRETE TOPPING SLAB ON GROUND FLOOR

## PROPOSED LEGALIZATION OF OF EXISTING NON CODE COMPLIANT 2ND FLOOR EXTERIOR DECK AND STAIR TO GRADE.

#### SCOPE OF WORK NOT PROPOSED IN THIS FILING:

- CHANGE IN USE, NO CHANTE IN OCCUPANCY, BUILDING CLASSIFCATIONS OR
- NO PROPOSED EXTERIOR CHANGES VISABLE FROM STREET
  NO PROPOSED CHANGE TO EXTERIOR WALLS SIDING OR THERMAL ENVELOPE OF EXISTING BUILDING.

#### ASSOCIATED FILINGS

AUTOMATIC FIRE SPRINKLER SYSTEM TO BE FILED UNDER SEPARATE FILING BY SENTRY AUTOMATIC FIRE SPRINKLERS

FEMA NOTE
THE PROPERTY IS NOT IN THE SPECIAL FLOOD HAZARD AREA, NO CHANGES ARE BEING MADE TO THE FLOOD ELEVATIONS.

### ENERGY CODE STATEMENT OF COMPLIANCE

TO THE BEST OF MY KNOWLEDGE, BELIEVE AND PROFESSIONAL JUDGMENT THE PROPOSED BUILDING IS IN COMPLIANCE WITH NYS 2020 ENERGY CODE. RESCHECK ENERGY ANALYSIS IS ALSO PROVIDED IN THIS

#### GENERAL CONDITIONS OF THE CONTRACT FOR CONSTRUCTION

ALL WORK SHALL CONFORM TO THE CONTINUE TO FTHE ZOUS THE ZOUS INTERNATIONAL BUILDING CODE AND WILL COMPLY WITH 2017 SUPPLIMENTAL REQUIREMENTS, AND THE BEST TRADE PRACTICES.

2. CONTRACTOR SHALL BE HELD TO HAVE VISITED AND EXAMINED THE PROJECT SITE BEFORE SUBMITTING HIS PROPOSAL SO AS TO FULLY UNDERSTAND ALL EXISTING CONDITIONS RELATING TO THIS WORK. THE NATURE AND SCOPE THEREOF AND THE FEATURES AND DIFFICULTIES THAT WILL AFFECT ITS EXECUTION. NO ALLOWANCE SHALL BE MADE FOR ANY EXTRA ANDOOR MATERIALS REQUIRED OR FOR DIFFICULTIES WHICH WOULD HAVE BEEN FORESEEN HAD THE REQUIRED INSPECTIONS BEEN MADE. THE CONTRACTOR SHALL TAKE ALL NECESSARY MEASUREMENTS FOR HIS WORK AT THE SITE VERIFY ALL CONDITIONS AND REPORT ANY DISCREPANCY IN DIMENSIONS OR EXISTING CONDITIONS TO THE ARCHITECT.

CONTRACTOR SHALL TARE ALL RELESSARY WINDSOLDMENTS OR EXISTING CONDITIONS TO THE CONDITIONS AND REPORT ANY DISCREPANCY IN DIMENSIONS OR EXISTING CONDITIONS TO THE CONDITIONS AND REPORT ANY DISCREPANCY IN DIMENSIONS OR EXISTING CONDITIONS TO THE PURPOSE OF THIS MEETING IS TO REVIEW THE PURPOSE OF THIS MEETING IS TO REVIEW THE PLANNED WORK AND TO ENSURE THAT THE WORK IS DOME IN ACCORDANCE WITH THE APPROVED PLANS.

4. BEFORE COMMENCING WORK, THE CONTRACTOR SHALL FILE ALL REQUIRED CERTIFICATES OF INSURANCE WITH THE DEPARTMENT OF BUILDINGS, OBTAIN ALL REQUIRED PERMITS, AND PAY ALL FEES REQUIRED BY GOVERNING NEW YORK CITY AGENCIES.

5. THE CONTRACTOR SHALL NOT DEVAITE FROM THE APPROVED CONSTRUCTION DOCUMENTS. THE CONTRACTOR IS ADVISED THAT HIS WORK WILL BE STOPPED IF AT ANY POINT IT HAS BEEN DETERMINED THAT THE WORK HAS ALTERED WITHOUT PRIOR WRITTEN APPROVAL FROM THE ARCHITECT.

6. THE CONTRACTOR SHALL PROVIDE ALL EQUIPMENT, OBTAIN PERMITS AND ERECT TEMPORARY CONSTRUCTION AS NECESSARY TO SAFEQUARD PERSONS AND PROPERTY, ALL MACHINERY, TOOLS, SERVICE LINES AND CONDUITS SHALL BE GUARDED, SHELDED OR BARRICADED TO PROVIDE SAFETY AND TO PREVENT CONTRACT WITH PUBLIC.

7. THE CONTRACTOR SHALL MAINTAIN STRUCTURAL INTEGRITY OF ADJOINING WALLS, GROUNDS AND PROPERTY AND PROFECT THE SAME FROM INJURY

8. CONTRACTOR SHALL MAINTAIN STRUCTURAL INTEGRITY OF ADJOINING WALLS, GROUNDS AND PROPERTY AND PROFECT THE SAME FROM INJURY

8. CONTRACTOR SHALL BEPARE AT HIS OWN COST ALL EXISTING MATERIAL OR EQUIPMENT DAMAGED AS ARE SULT OF CONSTRUCTION FOR THIS WORK.

10. CONTRACTOR SHALL BE RESPONSIBLE FOR KEEPING THE JOB SITE CLEAR OF TRASH AND DEBRIS AT ALL TIMES AND FOR THE REMOVAL OF ALL CONSTRUCTION DEBRIS FROM THE SITE PROR TO FINAL COMPILED FROM THE SITE PROR TO FINAL ALL TIMES AND FOR THE REMOVAL OF ALL CONSTRUCTION DEBRIS FROM THE SITE PROR TO FINAL ALL CONTRACTOR SHALL BE RESPONSIBLE FOR KEEPING THE JOB SITE CLEAR OF TRASH AND DEBRIS AT ALL TIMES AND FOR THE REMOVAL OF ALL CONSTRUCTION DEBRIS FROM THE SITE PROR TO FINAL ALL CONTRACTOR SH

AUTHORITIES.

13. THE CONTRACTOR SHALL BE RESPONSIBLE FOR THE PROTECTION OF ALL CONDITIONS AND MATERIALS WITHIN THE PROPOSED CONSTRUCTION AREA. THE CONTRACTOR SHALL DESIGN AND MATERIALS WITHIN THE PROPOSED CONSTRUCTION AREA. THE CONTRACTOR SHALL DESIGN AND INSTALL ADEQUATE SHORING AND BRACING FOR ALL STRUCTURAL OR REMOVAL TASKS. THE CONTRACTOR SHALL HAVE SULE RESPONSIBILITY FOR ANY DAMAGE OR INJURIES CAUSED BY OR DURING THE EXECUTION OF THE WORK.

14. THE CONTRACTOR SHALL LAY OUT HIS OWN WORK, AND SHALL PROVIDE ALL DIMENSIONS REQUIRED FOR OTHER TRADES (SPRINKLER, MECHANICAL, PLUMBING, ELECTRICAL, ETC.).

15. SPRINKLER, MECHANICAL, PLUMBING AND ELECTRICAL WORK SHALL BE PERFORMED BY PERSONS LICENSED IN THEIR TRADES, WHO SHALL ARRANGE FOR AND OBTAIN INSPECTIONS AND REQUIRED SIGNOFES.

OFFS.
16. THE CONTRACTOR SHALL DO ALL CUTTING, PATCHING, REPAIRING AS REQUIRED TO PERFORM ALL OF THE WORK INDICATED ON THE DRAWINGS, AND ALL OTHER WORK THAT MAY BE REQUIRED TO COMPLETE THE JOB.

7. ALL PIPING AND WIRING SHALL BE REMOVED TO A POINT OF CONCEALMENT AND SHALL BE PROPERLY

17. ALL PIPING AND WIRING SHALL BE REMOVED TO A POINT OF CONCEALMENT AND SHALL BE PROPERLY CAPPED OR PLUGGED.

18. THE CONTRACTOR SHALL GUARANTEE THE WORK FOR A MINIMUM OF ONE(1) YEAR FROM THE DATE OF ACCEPTANCE BY THE GOWNER AGAINST ALL DEFECTS IN MATERIAL ANDIOR WORKMANSHIP. THE IS GUARANTEE SHALL BE SUBMITTED IN WRITING BY THE CONTRACTOR TO THE OWNER.

19. THE CONTRACTOR SHALL PERFORM ALL WORK IN CONFORMANCE WITH THE HIGHEST DEGREE OF SKILL, QUALITY AND COMPLETIENS.

20. THE CONTRACTOR, UPON COMPLETION OF THE WORK, SHALL ARRANGE FOR DEPARTMENT OF BUILDINGS INSPECTIONS AND SIGNOFFS AS REQUIRED.

21. NO WORK SHALL BE DONE, EXCEPT BETWEEN THE HOURS OF 9:00 A.M. AND 5:00 P.M. MONDAY THROUGH FRIDAYS, EXCEPT AS OTHERWISE AGREED TO, NO WORK SHALL BE DONE ON SATURDAYS, SUNDAYS AND HOLIDAYS, AND NO WORK THAT CAN PRODUCE UNUSUAL NOISES THAT MIGHT BE DISTURBING TO BUILDING OCCUPANTS SHALL BE DONE BEFORE 1:00 A.M.

22. THE CONTRACTOR AND ALL SUB-CONTRACTORS AGREE TO ABIDE BY ALL REGULATIONS AS OUTLINED IN THE ALTERATION AGREEMENT

23. THE USE OF POWER TOOOLS SUCH AS PREUMATIC JACKHAMMERS SHALL BE PORHIBITED

24. PROPOSED WORK SHALL NOT ALTER OR RELOCATE THE MAIN PLUMBING, HEATING AND INTERCOM LINES.

#### SITE PROTECTION PLAN:

SITE PROTECTION PLAN:

LEGRESS.AT ALL TIMES IN THE COURSE OF CONSTRUCTION PROVISION SHALL BE MADE FOR ADEQUATE EGRESS.AT ALL TIMES IN THE COURSE OF CONSTRUCTION PROVISION SHALL BE MADE FOR ADEQUATE EGRESS.AT REQUIRED BY NEW YORK STATE, SOUTHOLD TOWN AND SUFFOLK COUNTY.

2. FINE SAFETY, ALL NECESSARY LAWS AND CONTROLS. INCLUDING THOSE WITH RESPECT TO OCCUPIED DWELLINGS, AS WELL AS ADDITIONAL SAFETY MEASURES NECESSITATED BY THE CONSTRUCTION SHALL BE STRICTLY OBSERVED.

3. HEALTH REQUIREMENTS. SPECIFICATION OF MEANS AND METHODS TO BE USED FOR CONTROL OF DUST, DISPOSAL OF CONSTRUCTION DEBRIS, PEST CONTROL AND MAINTENANCE OF SANITARY FACILITIES, AND LIMITATION OF NOISE TO ACCEPTABLE LEVELS SHALL BE INCLUDED.

3.1. THERE SHALL BE INCLUDED A STATEMENT OF COMPLIANCE WITH APPLICABLE PROVISIONS OF LAW RELATING TO LEDA AND ASSESTOS, AND SUCH STATEMENT SHALL DESCRIBE WITH PARTICULARITY WHAT MEANS AND METHODS ARE BEING UNDERTAKEN TO MEET SUCH COMPLIANCE.

4. COMPLIANCE WITH HOUSING STANDARDS. THE REQUIREMENTS OF THE NEW YORK CITY HOUSING MAINTENANCE CODE, AND, WHERE APPLICABLE, THE NEW YORK STATE MULTIPLE DWELLING LAW SHALL BE STRICTLY OBSERVED.

BE STRICTLY OBSERVED. STRUCTURAL SAFETY. NO STRUCTURAL WORK SHALL BE DONE THAT MAY ENDANGER THE SITE OR

CONTRACTED WORKERS
ANDISE RESTRICTIONS, WHERE HOURS OF THE DAY OR THE DAYS OF THE WEEK IN WHICH
CONSTRUCTION WORK MAY BE UNDERTAKEN ARE LIMITED MONDAY-FRIDAY 7 AM TO 5PM EXCEPT

FEDERAL HOLIDAYS

7.MAINTANING ESSENTIAL SERVICES, WHERE HEAT, HOT WATER, COLD WATER, GAS, ELECTRICITY, OR OTHER UTILITY SERVICES ARE PROVIDED IN SUCH BUILDING OR IN ANY DWELLING UNIT INCATED THEREN. THE SITE AND CONSTRUCTION PROTECTION PLAN SHALL SPECIFY THE MEANS AND METHODS TO BE USED FOR MAINTANING SUCH SERVICES DURING SUCH WORK IN ACCORDANCE WITH THE REQUIREMENTS OF SOUTHOLD TOWN A SUFFOLK COUNTY, IF A DISRUPTION OF ANY SUCH SERVICE IS ANTICIPATED DURING THE WORK, THEN SUCH PLAN SHALL SPECIFY THE ANTICIPATED DURATION OF SUCH PLAN SHALL SPECIFY THE ANTICIPATED DURATION OF SUCH DISRUPTION AND THE MEANS AND METHODS TO BE EMPLOYED TO MINIMIZE SUCH DISRUPTION, NCLUDING THE PROVISION OF SUFFICIENT ALTERNATIVES FOR SUCH SERVICE DURING SUCH DISRUPTION.

L	CATION	CEILING/		WALLS			BASE				FLOORS	COMMENTS
SOFFIT N E S W N E S	w	1										
	HALL	C-2	W-2	W-2	W-2	W-2	BB-1	88-1	88-1	88-1	F-2	
5	GUEST BATHROOM	C-2	W-3	W-2	W-2	W-2	88-1	BB-1	88-1	88-1	F-2	
GROUND FLO	GUEST BATHROOM	C-2	W-3	W-2	W-2	W-2	BB-1	88-1	BB-1	68-1	F-2	
31	BEDROOM 1, 2,3,4	C-1	W-2	W-3	W-3	W-3	-		-	12	F-2	
THE PLOOR GROUND	MECHANICAL ROOM	C-2	W-3	W-2	W-2	W-2	BB-1	BB-1	BB-1	88-1	F-2	
	LIVING ROOM	C-1	W-2	W-2	W-2	W-2	B3-1	BB-1	BB-1	88-1	F-2	
٦	STAR	C-1	W-1	W-1	W-1	W-1	BB-1	BB-1	88-1	88-1	F-1	
_	BATHROOM	C-2	W-2	W-2	W-2	W-2	BB-1	88-1	BB-1	88-1	F-1	
and FLOOR GROUND FLOOR	CLOSET	C-1	W-1	W-1	W-1	W-1	88-1	88-1	88-1	88-1	F-1	
5	OFFICE	C-1	W-1	W-1	W-1	W-1	-		-		Fet.	
5	BEDROOM	C-1	W-1	W-1	W-1	W-1	-		-	-	F-I	
w	1 SW GYPSUM BOARD, FINI	SHW/ 1 COAT BENN	AMIN MO	ORE REG	AL FIRST	COATLA		ER (216)		S BENJAN	MIN MOORE AURA	MATTE FINISH LATEX PAIN
-												
	(522), COLDA: TED	CHITTI T CORT DESIGN		OHE NEW	~ rmsi	CONTE	IEATHE	CH (Z IN)	a Z COM	SERVA	IN MOUNE AUNA	MATTE PRISH LATEX PART
W	2 5/6" MOISTURE RESISTAN MLDEW-PROOF INTERIOR	T GYPSUM BOARD, F R PAINT, COLOR: TBD	PASH W/	1 COAT Z	INSSER	IULLS EY	E ZERO V	ATER BA	SED PRI	VER & 2 C	COATS ZINSSER P	EPIMA-WHITE MOLD &
W	3 1/2" DUROCK CEMENT BO	ARD READY TO ACC	PT TLE				550					
W	6						-					
W	4											
								BASE TYP	ES			
88	6" WOOD BASE FINISH W/	1 COAT BENJAMIN M	DORE PL	EGAL FIRE	ST COAT	LATEX PE	UMER (21	E) & 2 CO	ATS BENL	AMIN MO	ORE AURA MATTE	FRESH LATEX PAINT (522)
							CE	ELING TY	PES			
C	58" GYPSUM BOARD, FINI (522), COLOR: WHITE DOV	SHW/1 COAT BENNY E # DC-17.	MIN MO	DRE REG.	AL FIRST	COATLA	TEX PRIM	ER (216)	A 2 COAT	S BENJA	MIN MOORE AURA	MATTE FINISH LATEX PAINT
C	5/8" MOISTURE RESISTAN MILDEW-PROOF INTERIOR	T GYPSUM BOARD, F PAINT, COLOR: WHI	TE DOVE	1 COAT Z # 0C-17.	INSSER E	ULLSEY	E ZERO W	ATER BA	SED PRI	ÆR \$ 2 C	COATS ZINGSER P	ERMA-WHITE MOLD &
							F	LOOR TY	PES			
F-1	34" X 10" TAG RIFT SAWN	WHITE OAK W/ WHIT	E OIL FR	ASH, STA	GGERED	JONTS V	V/ RANDO	M LENGT	HS MINL E	ENGTH T	OBESFT.	
F-2	SELF LEVELING CONCRET	E TOPPING SLAB GY	ER EXIST	ING CON	CRETE FI	CORING						
								STAR				
S	MATTE BLACK WIRLACK	OVER CHOSH STEEL	CTRINICE	DE WOOD	TOCANO	0						



## Generated by REScheck-Web Software **Compliance Certificate**

#### Project 511 Carpenter Street

Energy Code: Location: Construction Type: Project Type:

2 FINISH SCHEDULE 1 1/2" = 1'-0"

2020 New York City Energy Conservation Code

4 (5572 HDD)

#### Envelope Assemblies

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SHEET#	SHEET NAME	ISSUE DATE
T-001.00	TITLE SHEET	12/24/2020
T-002.00	GENERAL NOTES	12/24/2020
A-100.00	SITE PLAN	12/24/2020
A-101.00	REMOVAL PLAN	12/24/2020
A-102.00	REMOVAL PLAN	12/24/2020
A-103.00	REMOVAL PLAN	12/24/2020
A-104.00	GROUND FLOOR PLAN	12/24/2020
A-105.00	2ND FLOOR	12/24/2020
A-106.00	3RD FLOOR	12/24/2020
A-107.00	RCP AND ELECTRICAL PLANS	12/24/2020
A-108.00	RCP AND ELECTRICAL PLANS	12/24/2020
A-300.00	BUILDING SECTION	12/24/2020
P-100.00	PLUMBING RISER DIAGRAM	12/24/2020

THIS APPLICATION IS APPROVED ONLY FOR WORK INDICATED ON THE APPLICATION SPECIFICATION SHEET. A
OTHER MATTERS SHOWN ARE NOT TO BE RELIED UPON, OF
TO BE CONSIDERED AS EITHER BEING APPROVED OR IN

ANCE WITH APPLICABLE CODES.

#### Consultants:

SPINKLER ENGINEER SENTRY AUTOMATIC FIRE PROTECTION INC. 735 Flanders road Flanders, New York 11901

#### ISAAC - RAE

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T. 347-276-6093 E. clay@isaac-rae.com

## 511 CARPENTER ST.

**GREENPORT NY 11944** 

IR-02 Seal/ Signature:

MAR 1 1 2021

TITLE SHEET

T-001.00

PROX.	ARTIONS  ABOVE FINSHED FLOOR ACCESS PANEL ACCUSTICAL ADJACENT AND CONTINUENT ALLIMATION ALLIMATION ALLIMATION ALLIMATION ALLIMATION ARTHURAL BEJORICH CELING CELING CELING CELING CERING	CL. CONC. CONST. CONT. DTL. DM. DR. DBL. DN. DWG. EA. ELEC.	CLOSET COLLIAN CONCRETE CONSTRUCTION CONTINUOUS DETAL DMENSION DOOR. DOUBLE DOWN DAWNING EACH ELECTRIC/FLECTRICAL	EL EMER. EQ. EQPT. EXIST. EXIS. FIN. FL. FPRF. S.C. FL. FLUOR. FT.	ELEVATION EMERGENCY EQUAL EQUAL EQUAL EXITING EXTENOR FINISH FLOOR FIREPROOF SELF-CLOSING FLOOR	B.O. GL. GRL. GFI. GWB HNDRL. HDWD. HVAC H.M. HORIZ. IN.	BY OTHERS/OWNER CLASS GRILLE GROUND FAULT INTER. GYPSUM WALLBOARD HANDRAIL HARDWOOD HEATING, VENT. & A/C HOLLOW METAL HORZONITAL INCHES INSULATION	LAM. LV. MATL MAX. MECH. MIN. MISC. MLDG. MTD. MUL. NOM.	LAMINATE LOW VOLTAGE MATERIAL MAXIMIN MECHANICAL METAL MINIMIM MISCELLANEOUS MOLDING MOUNTED MULLION NOMINAL NOT APPLICABLE	N.I.C. NO. O.C. OPPG OPPJOPH PTD. PARTN. PL PUYWD., PL POS. QTY. REC. REO'D	NOT IN CONTRACT NAMEER ON CENTER OFFENSE OFPOSITE-COPPOSITE HAND PANTITION PLASTER Y RITWOOD POINT OF SERVICE QUANTITY RCCSSED	R.A. REV. R.O. SCHED. SECT. SHT. SM. SC. SQ.FT. SSTL. STD. STD.	RETURN AIR REVISE/REVISION ROUGH OPENING SCIEDULE SECTION SHEET SIMILAR SOLID CORE SQUARE FOOT STAINLESS STEEL STANDARD STEEL STORAGE	TEL. T.B.D. TYP. U.O.N. V.I.F. VT/V.CT W/ W/O WD.	TELEPHONE TO BE DETERMINED TYPICAL UNLESS OTHERWISE NOTED VERIFY IN FIELD VINTL COMPOSITION TILE WITH WITHOUT WOOD
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SYMBOL LEGEND

SI - SECTION NUMBER

1 - DOOR NUMBER

## 1 GENERAL NOTES

### **GENERAL NOTES:**

#### CONSTRUCTION NOTES:

- THE GENERAL CONTRACTOR IS RESPONSIBLE FOR ENSURING THAT ALL WORK AND CONSTRUCTIO MEET THE REQUIREMENTS OF THE 2018 INTERNATIONAL RESIDENTIAL BUILDING CODE AND NEW YORK DEPARTMENT OF STATE 2017 UNIFORM CODE SUPPLEMENT.
- DIMENSIONS SHALL TAKE PRECEDENT OVER SCALED DRAWINGS (DO NOT SCALE DRAWINGS).
  REFER TO THE WINDOW AND DOOR SCHEDULE FOR EXTERIOR
- REFER TO CIVIL ENGINEERING DRAWINGS FOR GRADING PLANS REFER ARCHITECTURAL DRAWINGS FOR BUILDING ELEVATIONS
- INCLUDING SLAB AND FINISH FLOOR ELEVATIONS
  130 MPH WIND LOAD REQUIREMENTS SHALL BE TAKEN INTO ACCOUNT DURING CONSTRUCTION.

#### FOUNDATION NOTES:

- THE GENERAL CONTRACTOR AND MASON TO REVIEW PLANS, ELEVATIONS, DETAILS AND NOTES TO DETERMINE INTENDED HEIGHTS OF FINISHED FLOORS ABOVE GRADE.
- GENERAL CONTRACTOR TO RETAIN SURVEYOR TO SET OR VERIFY DATUMS AND FINISHED FLOOR ELEVATIONS DRAINAGE AS REQUIRED BY HALL MEET THE REQUIREMENTS OF THE
- 2015 INTERNATIONAL RESIDENTIAL BUILDING CODE AND NEW YORK DEPARTMENT OF STATE 2017 UNIFORM CODE SUPPLEMENT.
- ALL FOOTINGS MUST REST ON APPROPRIATE BEARING MATERIAL SEE STRUCTURAL ENGINEERS DRAWINGS FOR ADDITIONAL DETAILS ANY NEW CONCRETE WALLS BEING ATTACHED TO EXISTING CONCRETE
- STRUCTURE TO BE INSTALLED WITH #5 RE-BAR, MIN 18" LONG AT 12"0.C. MIN EMBEDD TO BE 9" USE APPROVED EPOXY FOR ANCHORING UNLESS OTHER WISE NOTED, ALL SLABS ON GRADE TO BE 4000P ST
- CONCRETE TO BE POURED AT MIN 4\* THICK SAND OR GRAVEL FILL WITH 6X6 WIRE MESH REINFORCING. SLAB THICKNESS TO BE MIN 5\* THICK.
- ALL FILL TO BE COMPACTED TO 95% RELATIVE DENSITY AT 6" MAX LIFTS CRAWL SPACES TO BE PROVIDED WITH MIN. 24"X24" ACCESS OPENING. UNCONDITIONED CRAWL SPACES TO HAVE 8X16" CAST IRON
- FOUNDATION VENTS FOR EVERY 150 SOFT OF AREA
  DAMPPROOF EXTERIOR OF FOUNDATION WITH BITUMINOUS COATING AS REQUIRED BY 2015 INTERNATION BUILDING CODE AND NEW YORK DEPARTMENT OF STATE 2017 SUBPPLEMENTAL CODE. A 6 MIL
  POLYETHYLENE FILM SHALL BE APPLIED TO THE BELOW GRADE PORTION
  OF EXTERIOR WALLS PRIOR TO BACKFILLING

#### FRAMING NOTES

- ALL FRAMING TECHNIQUES SHALL MEET THE REQUIREMENTS OF THE 2015 INTERNATIONAL BUILDING CODE AND NEW YORK DEPARTMENT OF STATE 2017 UNIFORM CODE SUPPLEMENT
- STRUCTURAL LUMBER SHALL BE GREEN DOUGLAS FIR LARCH NO. 2, OR BETTER, UNLESS OTHERWISE NOTED ON THE PLANS
- INTERIOR METAL FRAMING SHALL BE 18 GAUGE OR BETTER UNLESS OTHER WISE NOTED ON THE PLANS
  FLOORS, WALLS, CEILINGS AND RAFTERS TO BE SPACED AT 16
- INCHES O.C. UNI ESS NOTED
- UNLESS OTHERWISE NOTED , ALL BEARING WALL HEADERS TO BE (2) 2X10 #2 + BTR. DOUG. FIR.BEARING WALL HEADERS TO HAVE (2) JACK STUDS AND (2) FULL LENGTH STUDS ON EACH SIDE OF ALL OPENINGS. LVL HEADERS TO HAVE (3) JACK STUDS AND (2) FULL LENGTH STUDS ON EACH SIDE OF OPENINGS. BEARING WALL WINDOW SILLS SHALL ALSO HAVE (2) WINDOW SILL PLATES FOR 2X4 WALL OPENINGS BETWEEN 4'1 AND 6'0 AND 2X6 WALL OPENINGS BETWEEN 5'11 AND 8'9.
- PROVIDE FIRE AND BLOCKING WHERE APPLICABLE.
  ALL FLUSH BEAMS/HEADERS TO BE INSTALLED WITH HEAVY DUTY
  GALVINIZED HANGERS AND ANCHORS WHERE APPLICABLE TO ALL CONNECTING JOISTS
- DOUBLE UP FLOOR JOISTS UNDER WALLS THAT RUN PARALLEL TO THE FLOOR JOIST AND UNDER BATHTUBS.FLOORS TO HAVE CERAMIC TILE INSTALLED SHALL BE VERIFIED FOR PROPER LOAD CAPACITY UNLESS NOTED ON PLANS.

  7). PROVIDE 2 - 1-3/4" THICK MICROLAMS ( HEIGHT TO MATCH FLOOR
- JOISTS) AROUND STAIRWELL AND/OR OTHER ACCESS OPENINGS UNLESS OTHERWISE NOTED (TYPICAL).
- PROVIDE BLOCKING/BRIDGING IN FLOOR JOISTS AT 8'0 O.C., USE SOLID BLOCKING IN FLOOR JOISTS UNDER ALL BEARING WALLS.
  PROVIDE INSULATION BAFFLES AT EAVE VENTS BETWEEN RAFTERS.
- INSTALL DRAFT BLOCKING AS NEEDED.
  UNLESS OTHERWISE NOTED, ALL ROOFS AND WALLS TO HAVE A
  MINIMUM 1/2" THICK, 4-PLY FIR CDX EXTERIOR SHEATHING GRADE
- PLYWOOD, PLYWOOD TO COVER OVER PLATES AND HEADERS.
  UNLESS OTHERWISE NOTED USE 3/4" THICK T&G PTS FIR OR
  ADVANTECH PLYWOOD SUBFLOOR ADHERED WITH PL400 ADHESIVE
- AND SCREWED TO FLOOR JOISTS, FINISHED FLOOR TO BE INSTALLED OVER SUBFLOOR AS PER MANUFACTURE'S INSTRUCTIONS. 13. ALL BATHROOM WALLS TO HAVE 5/8" THICK MOISTURE-RESISTANT
- SHEETROCK.

  1 HR FIRE RATED ASSEMBLYS TO HAVE ONE LAYER OF 5/8" TYPE X SHEET ROCK AND TO MEET ANSI/III 263 AND UI DESIGN NO. 11419
- 2 HR FIRE RATED ASSEMBLYS TO HAVE TWO LAYERS OF 5/8" TYPE X SHEET ROCK AND TO MEET ANSI/UL 263 AND UL DESIGN NO. U419 ALL ROOFS AND SHEATHING TO BE INSTALLED WITH ICE AND WATER SHIELD, HENRY BLUE SKIN OR APPROVED EQUAL.
  ALL FLAT ROOFS TO BE APPLIED WITH AN EPDM 6MILL MATERIALS
- ALL SILL PLATES AND WOOD IN CONTACT WITH CONCRETE TO BE PRESSURE TREATED. SILL PLATES TO BE INSTALLED WITH FOAM SILL GASKETS AND COP-R-TEX TERMITE SHIELD OR APPROVED EQUAL.

#### FIREBLOCKING NOTES

AS REQUIRED BY CURRENT 2018 IBC/2017 SUPPLEMENT - FIREBLOCKING REQUIRED. FIREBLOCKING SHALL BE PROVIDED TO CUT OFF ALL CONCEALED DRAFT OPENINGS (BOTH VERTICAL AND HORIZONTAL) AND TO FORM AN EFFECTIVE FIRE BARRIER BETWEEN STORIES, AND BETWEEN A TOP STORY AND

FIREBLOCKING SHALL BE PROVIDED IN WOOD-FRAME CONSTRUCTION IN THE FOLLOWING LOCATIONS:

- IN CONCEALED SPACES OF STUD WALLS AND PARTITIONS, INCLUDING FURRED SPACES, AT THE CEILING AND FLOOR LEVELS, CONCEALED HORIZONTAL FURRED SPACES SHALL ALSO BE FIREBLOCKED AT INTERVALS NOT EXCEEDING 10 FEET. BATTS OR BLANKETS OF MINERAL OR GLASS FIBER SHALL BE ALLOWED AS FIREBLOCKING IN WALLS CONSTRUCTED USING PARALLEL ROWS OF STUDS OR STAGGERED STUDS. AT ALL INTERCONNECTIONS BETWEEN CONCEALED VERTICAL AND
- HORIZONTAL SPACES SUCH AS OCCUR AT SOFFITS. DROP CEILINGS AND COVE CEILINGS.
  IN CONCEALED SPACES BETWEEN STAIR STRINGERS AT THE TOP AND
- IN CONCEALED SPACES BY WEEN STAIN STRINGERS AT THE TOP AND SOTTOM OF THE RUN. ENCLOSED SPACES UNDER STAIRS SHALL COMPLY WITH CURRENT N.Y.S. RESIDENTIAL CODE.
  AT OPENINGS AROUND VENTS, PIPES AND DUCTS AT CEILING AND FLOOR LEVEL, TO RESIST THE FREE PASSAGE OF FLAME AND PRODUCTS OF
- RECOMMENDED FIRE BLOCKING PRODUCTS BOSS 814 OR APPROVED
- EQUAL TO MEET ASTM E-814 (UL 1479)
  PROVIDE 5/8" TYPE-X SHEETROCK FIRE STOPPING AT 10'0 MAXIMUM
- DISTANCES FOR NON ACCESSIBLE AREAS.

#### INSULATION

- INSULATION TO MEET OR EXCEED NYS ECCC 2020 ENERGY CODE 2018 IBC AND 2017 SUPPLEMENTAL CODE INSULATION TO FOLLOW SPECIFICATIONS AS OUTLINED IN RESCHECK
- VAULTED CEILINGS INSULATED TO R45 OR GREATER
  ABOVE GRADE WALLS TO BE INSULATED TO R-32 OR GREATER
- FOUNDATION WALLS TO BE INSULATED TO R-10 OR GREATER FRAMED FLOORS TO BE INSULATED TO R-32 OR GREATER SLABS ON GRADE TO BE INUSLATED TO R-10 UNDER SLAB.

#### REQUIRED INSULATION AS FOLLOWS

- CEILINGS: 4\* SPRAYED CLOSED CELL CONTINUOUS INSULATION R6.5 per inch. WITH ROCKWOOL R23 5-1/2\* for total of R49
- WALLS: 3" SPRAED CLOSED CELL CONTINUOUSE INSULATION R6.5 PER INCH. WITH ROCKWOOL R15 3-1/2" FOR TOTAL OF R34.5
  FLOORS: 3" SPRAYED CLOSED CELL CONTINUOUSE INSULATION R6.5 PER INCH. WITH ROCKWOOL R15 3-1/2" FOR TOTAL OF R34.5
- SLABS 3" EXPANED POLYSTYRENE INSULATION FOR R12

#### PLUMBING NOTES

- All water supply, drainage and venting to be installed as per IBC 2015/2017 SUPPLEMENT, and shall meet Sulfolk County Health Department requirements as stated on septic permit
- Verify septic system with the Engineer for Suffolk County Health Department
- 3). If wall studs, plates or joists are cut out during installation for any plumbing related work, provide adequate bracing and plates to protect and secure the structure. Verify with the state code and manufacture's recommendation for maximum hole size and spacing permitted

#### **HVAC SYSTEM NOTES**

- 1). Mechanical subcontractor is responsible for adhearing to all applicable codes and safety
- 2). HVAC subcontractor is to fully coordinate all system data and requirements with the
- 3). HVAC subcontractor to provide final system layout drawing / shop drawings and submit it to **ELECTRICAL NOTES:**
- 1). All electrical to be installed as per IBC 2018/2017 SUPPLEMENT
- All electrical work shall be approved by a qualified Underwriter.
   Install Smoke detectors and Carbon Monoxide detectors throughout as required.
- N.Y.S. Residential Construction Code.

## THESE NOTES ARE ONLY TO BE REFERRED TO IF MENTIONED IN SCHEDULE NOTES ONLY.

DESIGN CRITERIA 2015 INTERNATIONAL BUILDING CODE /2017 SUPPLEMENT

JOINT DESCRIPTION	NAIL OTY.	NAIL SPACING	NOTES TOE-NAIL	
RAFTER TO TOP PLATE	8' WALL: 3-8d 10' WALL: 4-8d	EACH RAFTER		
CEILING JOIST	8' WALL: 3-8d	EACH	TOE-NAIL	
TO TOP PLATE	10' WALL: 4-8d	JOIST		
CEILING JOIST TO	AS PER TABLE 3.7	EACH	FACE	
PARALLEL RAFTER	WFCM -		NAIL	
CEILING JOIST LAPS	AS PER TABLE 3.7	EACH	FACE	
OVER PARTITION	WFCM -	LAP	NAIL	
COLLAR TIE TO RAFTER	AS PER TABLE 3.4 WFCM -	EACH	FACE NAIL TOE NAIL	
BLOCKING TO RAFTER	2 - 8d	EACH END		
RIM	2 - 16d	EACH	END	
TO RAFTER		END	NAIL	

JOINT DESCRIPTION	NAIL OTY.	NAIL SPACING	NOTES
TOP PLATE TO	2 - 16d	PER	FACE NAIL
TOP PLATE		FOO	SEE NOTE: 1
TOP PLATES AT INTERSECTIONS	4 - 16d	JOINTS EA. SIDE	FACE NAIL
STUD TO	2 - 16d	24"	FACE
STUD		O.C.	NAIL
HEADER	16d	16" O.C.	FACE
HEADER		ALONG	NAIL
TOP OR PLATE TO STUD	2 - 16d	PER 2x4	END
	3 - 16d	PER 2x6	NAIL
BOTTOM PLATE FLOOR JOIST, BAND END JOIST OR	2 - 16d	PER FOO	FACE NAIL SEE NOTE: 1,2

LOO	R	_	_	

JOINT DESCRIPTION	NAIL QTY.	NAIL SPACING	NOTES
JOIST TO:	4 - 8d	PER	TOE
SILL, TOP PLATE OR GIRDER		JOIST	NAIL
BRIDGING	2 - 8d	EACH	TOE
TO JOIST		END	NAIL
BLOCKING	2 - 8d	EACH	TOE
TO JOIST		END	NAIL
BLOCKING	3 - 16d	EACH	TOE
SILL OR TOP PLATE		BLOCK	NAIL
LEDGER STRIP	3 - 16d	EACH	FACE
TO		JOIST	NAIL
JOIST ON	3 - 8d	PER	TOE
TO		JOIST	NAIL
BAND JOIST	3 - 16d	PER	END
TO JOIST		JOIST	NAIL
BAND JOIST TO:	2 - 16d	PER	TOE NAIL
SILL OR TOP PLATE		FOO	SEE NOTE: 1

JOINT DESCRIPTION	NAIL QTY.	NAIL SPACING	
STRUCTURAL	8d	AS PER TABLE 3.8 WFCM -	

#### EILING SHEATHING

OINT DESCRIPTION	NAIL OTY.	NAIL SPACING
GYPSU WALLBOAR	5d	7° O.C. 10° O.C . FIELD

#### WALL SHEATHING

DINT DESCRIPTION	NAIL QTY.	NAIL SPACING
STRUCTURAL PANELS	8d	AS PER TABLE 3.9 WFCM -
7/16" OSB PLYWOO	6d	3" O.C. 6" O.C. FIELD
GYPSU WALLBOAR	5d	7" O.C. 10" O.C . FIELD

#### OOR SHEATHING

JOINT DESCRIPTION	NAIL QTY.	NAIL SPACING
TRUCTURAL 1° OR LESS	8d	6" O.C. 12" O.C. FIELD

#### NOTES

#### DRAWING ISSUE

NO.	DATE	ISSUED FOR
1	12:24/2020	Greenport Village Review
2	2.05.2020	Greenport ZBA Submittal
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OTHER MATTERS SHOWN ARE NOT TO BE RELIED UPON, OI
TO BE CONSIDERED AS EITHER BEING APPROVED OR IN
ACCORDANCE WITH APPLICABLE CODES.

#### Consultants:

SPINKLER ENGINEER SENTRY AUTOMATIC FIRE PROTECTION INC. Flanders, New York 1190

Architect of Record:

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Contact; Isaac Clay Coffey NYS LIC#039767

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511 CARPENTER ST. **GREENPORT NY 11944** 

IR-02

MAR 1 1 2021


Drawing Title GENERAL NOTES

T-002.00







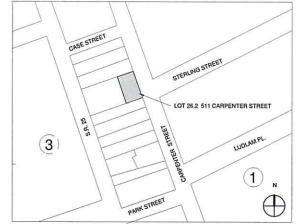

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DRAWING ISSUE

ISSUED FOR

SPINKLER ENGINEER
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735 Flanders road
Flanders, New York 11901

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Project:

511 CARPENTER ST.

**GREENPORT NY 11944** 

Project No.: IR-02


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Date: Scale:
AS NOTED

Drawing Title:
SITE PLAN

Drawing No.:

A-100.00

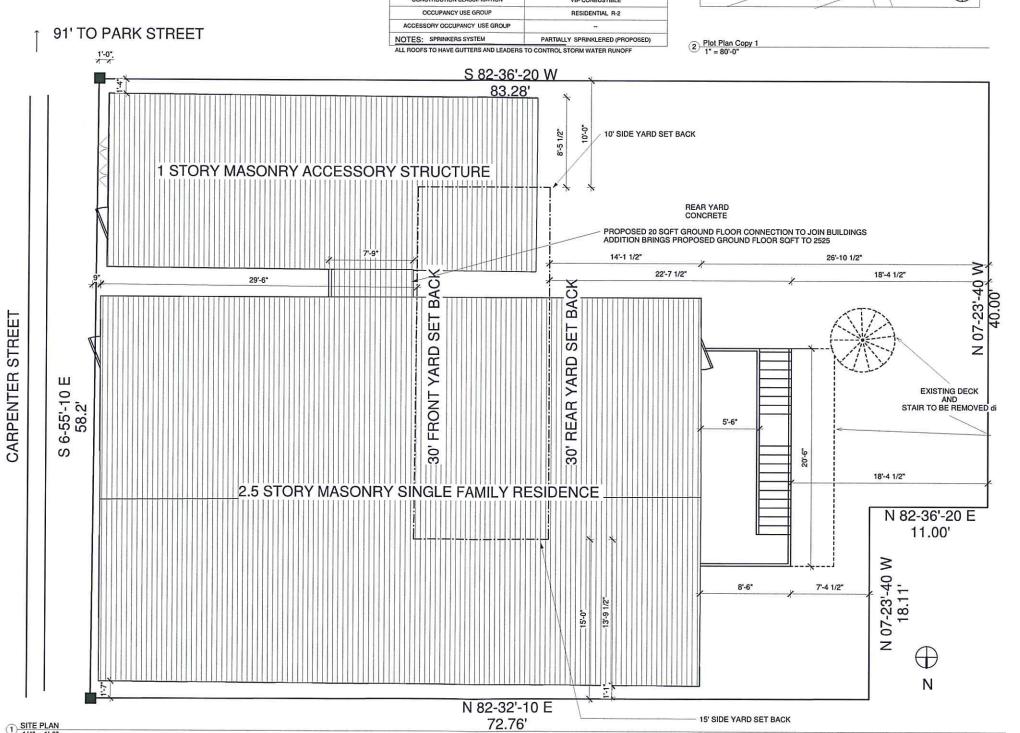

D10

D1

D9 -

D8

D1 -

1) GROUND FLOOR DEMOLITION PLAN

#### **DEMOLITION NOTES**

- D1. Remove exiting non load bearing interior walls
- D2. Existing stair to 2nd floor to be retained
- D3. Remove existing powder room. Plumbing fixtures to be relocated
  D4. Remove existing flooring in this area to prepare for proposed bathroom.
- D5. Remove existing non complaint deck, stair and other associated structure
- D6. Remove existing doors and replace with fixed Marvin picture window
- D7. Demo existing doors and replace with fixed marvin picture window
  D7. Demo existing handrail to be replaced with proposed code compliant
  haindrail in proposed plan
  D8. Remove ceiling in this location for fire proposed fire sprinkler system
  D9. Existing stair to remain protected during construction.
- D10 Remove portion of exterior wall

#### **NOTES**

#### DRAWING ISSUE

NO.	DATE	ISSUED FOR
1	12:24/2020	Greenport Village Review
2	2 115 21129	Greenport ZBA Submittel
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SPINKLER ENGINEER SENTRY AUTOMATIC FIRE PROTECTION INC. 735 Flanders road Flanders, New York 11901

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## 511 CARPENTER ST.

**GREENPORT NY 11944** 

Project No.: IR-02

Seal/ Signate

MAR 1 1 2021

WALL TYPE LEGEND

Drawing Title: REMOVAL PLAN

A-101.00

D3. Remove existing powder room. Plumbing fixtures to be relocated D4. Remove existing flooring in this area to prepare for proposed bathroom.

D5. Remove existing non complaint deck, stair and other associated structure

D6. Remove existing doors and replace with fixed Marvin picture window
D7. Demo existing handrail to be replaced with proposed code compliant
haindrail in proposed plan

D8. Remove ceiling in this location for fire proposed fire sprinkler system
D9. Existing stair to remain protected during construction.

D10 Remove portion of exterior wall

NOTES

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#### Consultants:

SPINKLER ENGINEER SENTRY AUTOMATIC FIRE PROTECTION INC. 735 Flanders road Flanders, New York 11901

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511 CARPENTER ST.


**GREENPORT NY 11944** 

Project No.: IR-02

MAR 1 1 2021

Drawing Title: REMOVAL PLAN

A-102.00

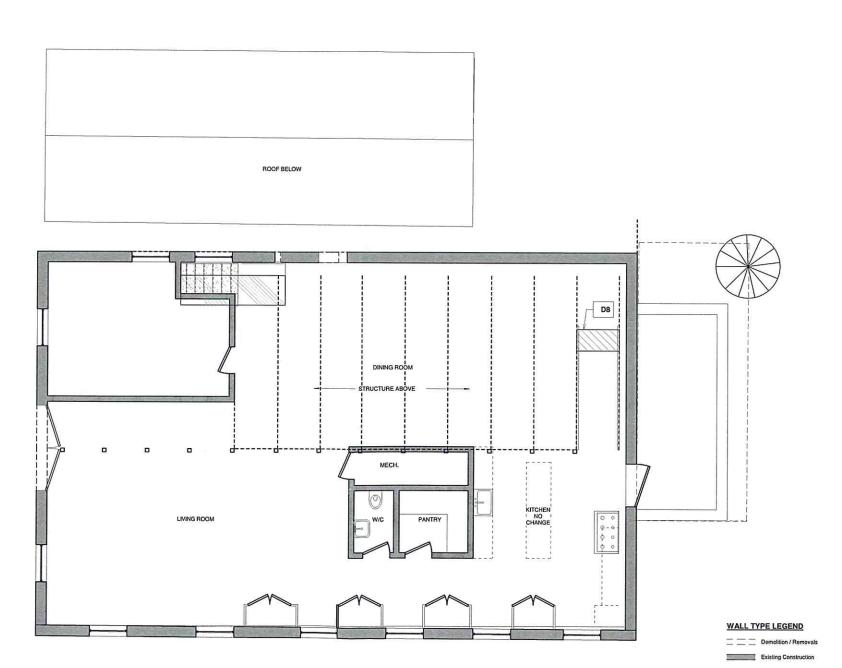

#### NOTES

#### **DEMOLITION NOTES**

- D1. Remove exiting non load bearing interior walls
- D2. Existing stair to 2nd floor to be retained
- D3. Remove existing powder room. Plumbing fixtures to be relocated D4. Remove existing flooring in this area to prepare for proposed bathroom.
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- D6. Remove existing doors and replace with fixed Marvin picture window D5. Hemove existing doors and replace with fixed marvin picture window
  D7. Demo existing handrail to be replaced with proposed code compliant
  haindrail in proposed plan
  D8. Remove ceiling in this location for fire proposed fire sprinkler system
  D9. Existing stair to remain protected during construction.

Existing Construction

D10 Remove portion of exterior wall

#### DRAWING ISSUE

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37 Noble Street Brooklyn, NY 11222 Contact; Peter Storey

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ROOF BELOW D7 D8 D7 WALL TYPE LEGEND

511 CARPENTER ST.

**GREENPORT NY 11944** 


Project No.: IR-02

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Date: Scale: AS NOTED Drawing Title: REMOVAL PLAN

A-103.00


1 3RD FLOOR DEMOLITION PLAN



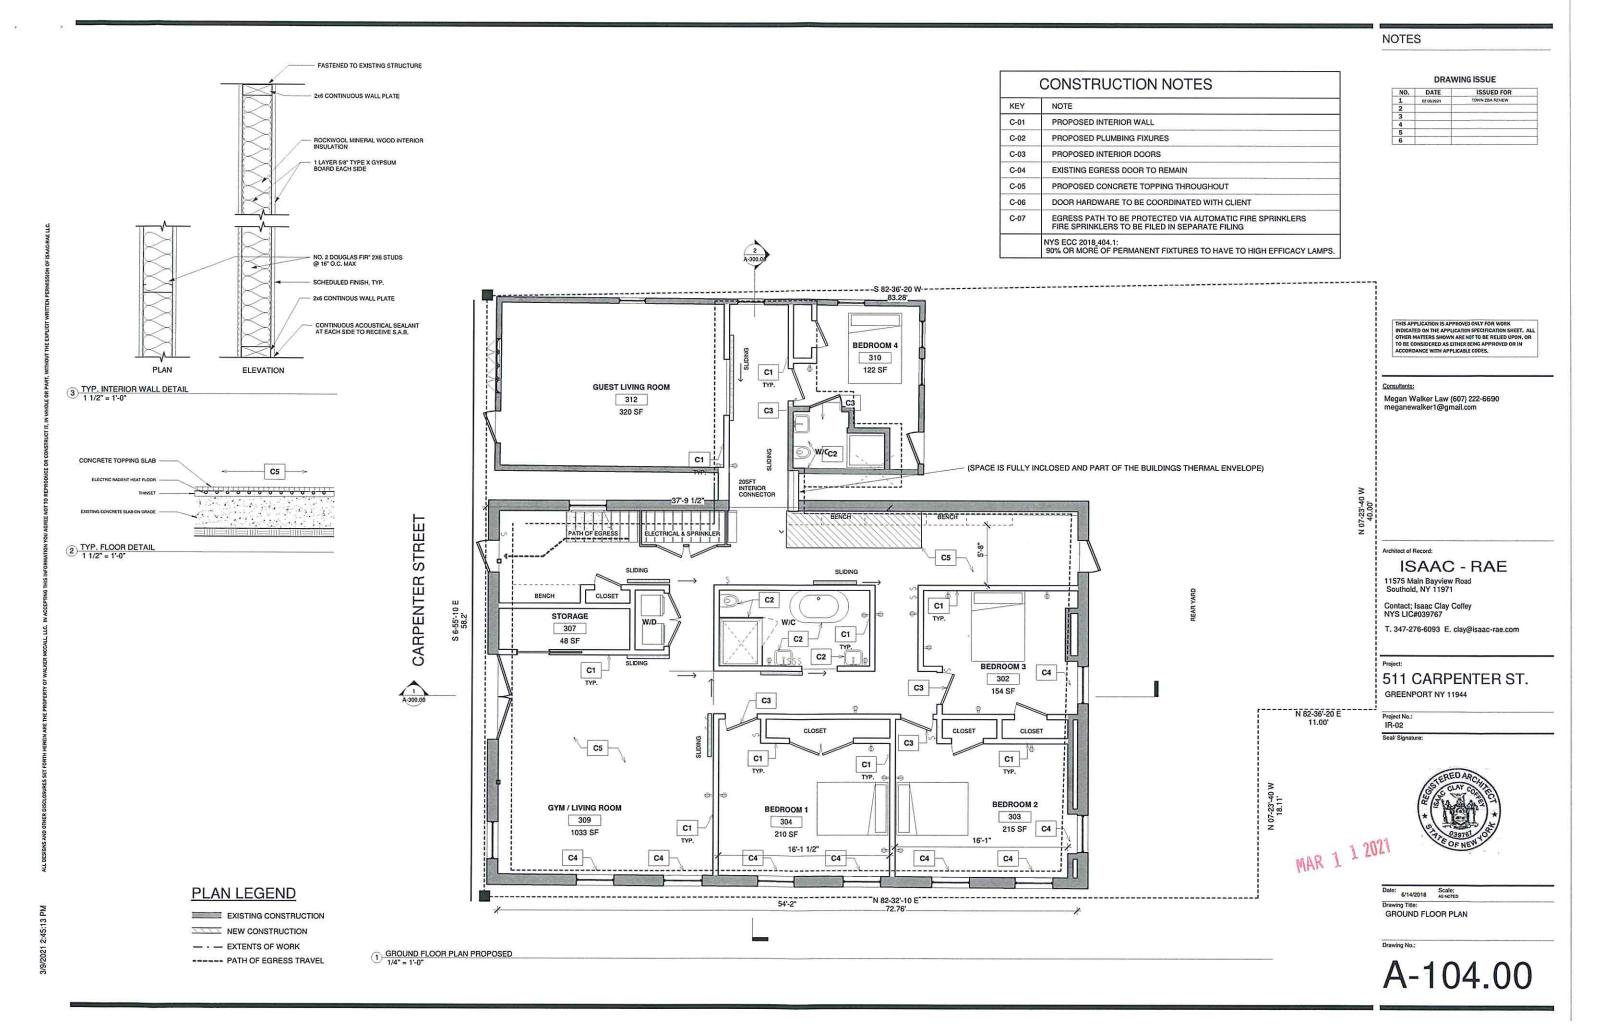

#### DRAWING ISSUE

NO.	DATE	ISSUED FOR
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#### Consultants:
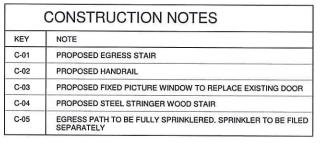
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Architect of Record:

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Project:

## 511 CARPENTER ST. GREENPORT NY 11944

GREENPORT NY 11

IR-02

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MAR 1 1 2021


Date: Scale:
AS NOTED

Drawing Title:
2ND FLOOR


Don to a No

404.1: 90% OR MORE OF PERMANENT FIXTURES TO HAVE TO HIGH EFFICACY LAMPS.

A-105.00

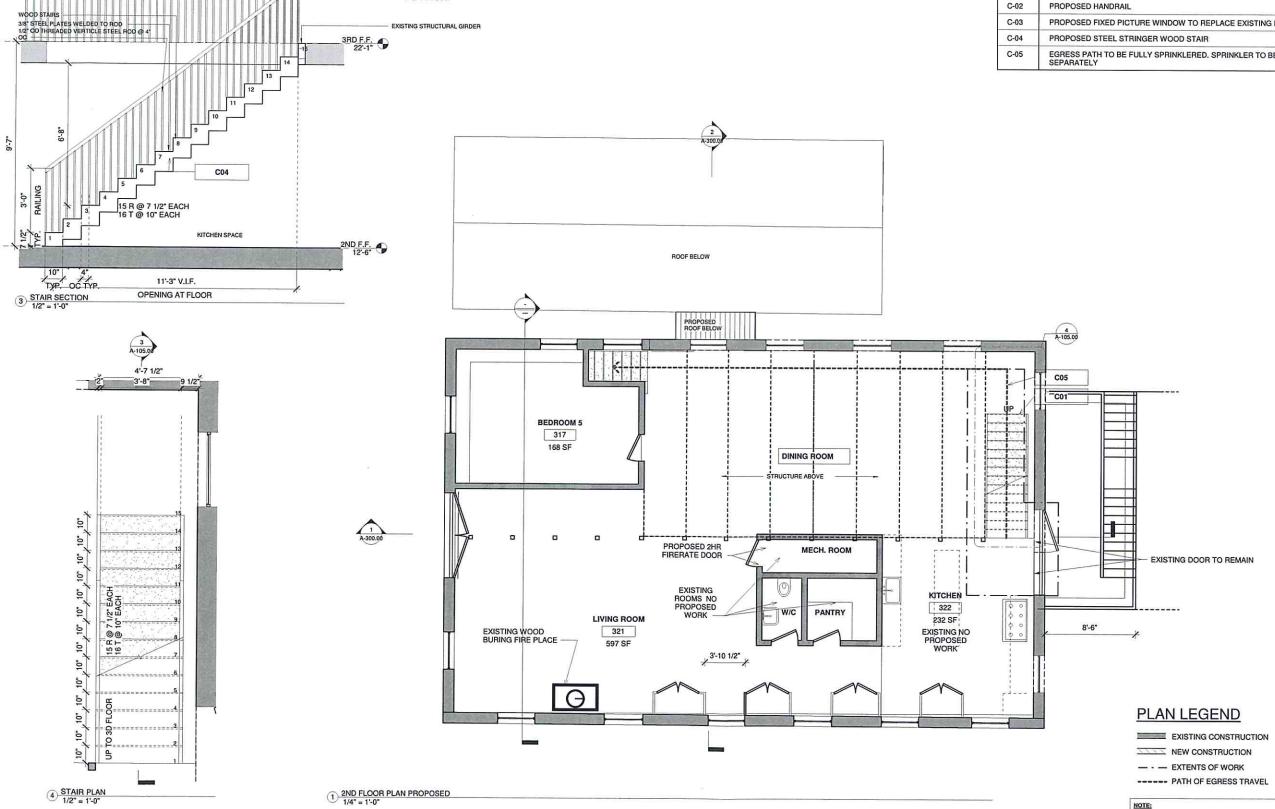

- CASEMENT WINDOW

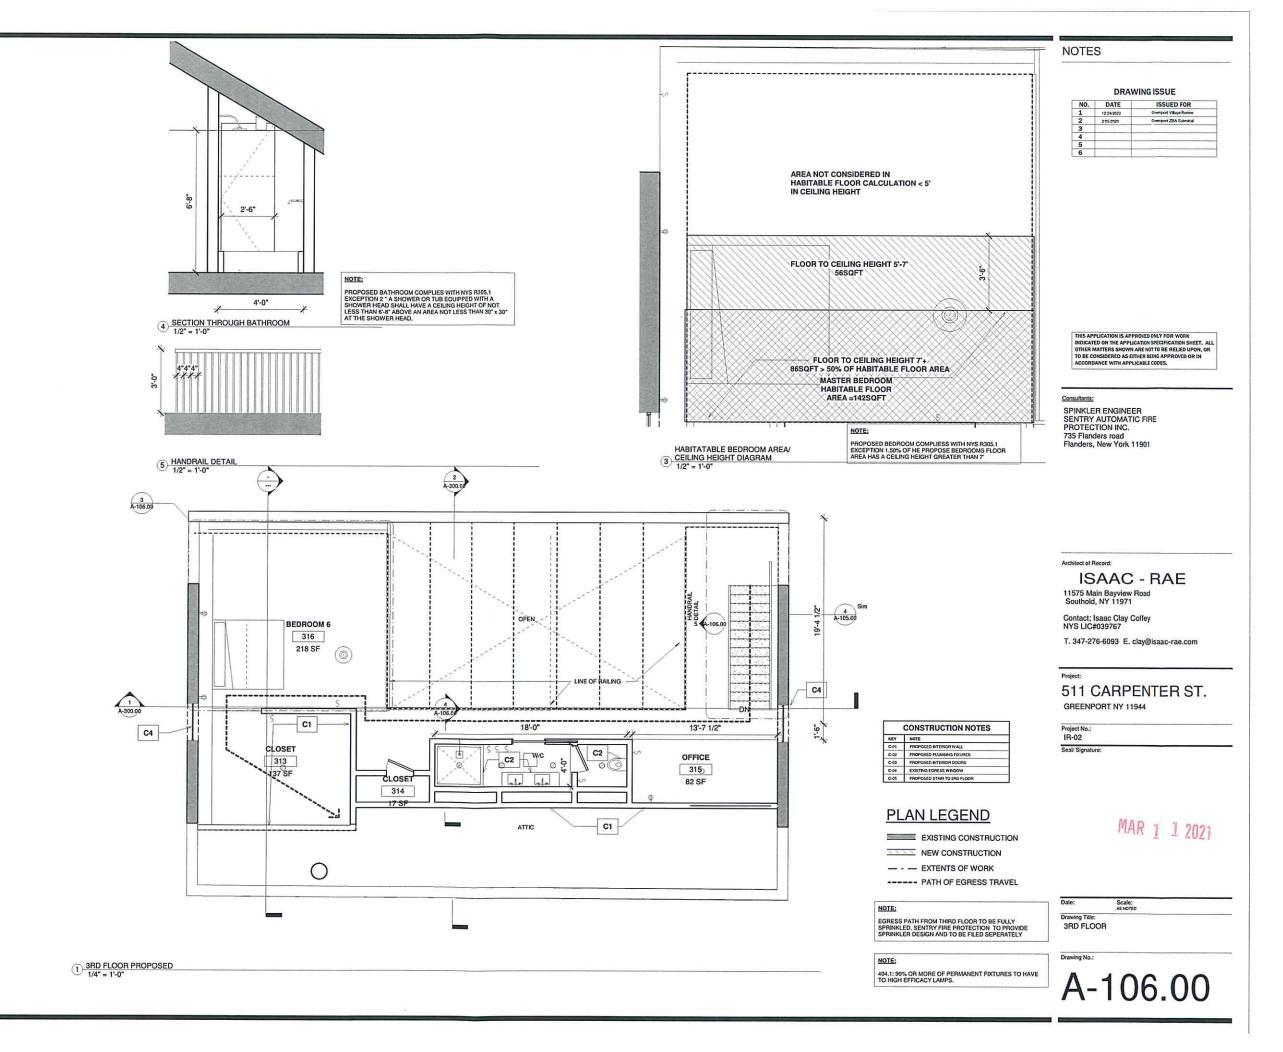

/9/2021 2:45:14 PM

## NOTES

### REFLECTED CEILING PLAN LEGEND

 RECESSED DOWNLIGHT LIGHT SWITCH PENDANT LIGHTING DS DOOR SWITCH

BATH FAN

#### REFLECTED CEILING PLAN NOTES

1. FIRE RATED CEILING BOXES TO BE PROVIDED AT ALL PENETRATION IN FIRE RATED CEILING, INCLUDING BUT NOT LIMITED TO RECESSED LIGHTING.
2. [402.4.5] IC-RATED RECESSED LIGHTING FIXTURES SEALED AT HOUSING/INTERIOR FINISH AND LABELED TO INDICATE ≤2.0 CFM LEAKAGE AT 75 PA.
REQUIREMENT RESOLUTION
3) [1403.1.1] PROGRAMMABLE THERMOSTATS INSTALLED FOR CONTROL OF PRIMARY HEATING AND COOLING SYSTEMS AND INITIALLY SET BY MANUFACTURER TO CODE SPECIFICATIONS.
4) [403.6.1] ALL MECHANICAL VENTILATION SYSTEM FANS NOT PART OF TESTED AND LISTED HVAC EQUIPMENT MEET EFFICACY AND AIR FLOW LIMITS PER TABLE R403.6.1.

#### DRAWING ISSUE

NO.	DATE	ISSUED FOR
1	12 24/2020	Greenport Village Review
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## 511 CARPENTER ST.


**GREENPORT NY 11944** 

Project No.:

MAR 1 1 2021

Drawing Title:
RCP AND ELECTRICAL PLANS

A-107.00

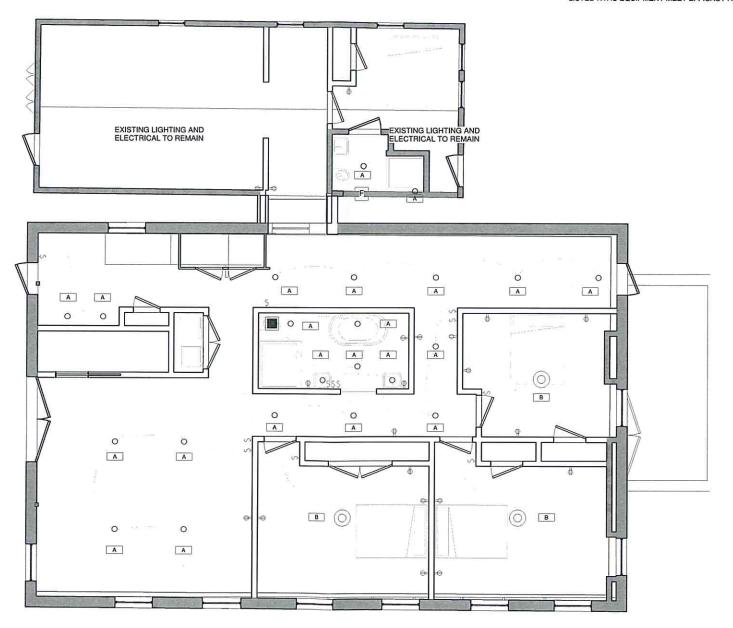

GROUND FLOOR RCP AND ELECTRICAL

1 PLAN
1/4" = 1'-0"

NO.	DATE	ISSUED FOR
1	12:24/2020	Greenport Village Review
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#### REFLECTED CEILING PLAN LEGEND

RECESSED DOWNLIGHT LIGHT SWITCH PENDANT LIGHTING DS DOOR SWITCH BATH FAN

#### REFLECTED CEILING PLAN NOTES

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REQUIREMENT RESOLUTION

3) [403.1.1] PROGRAMMABLE THERMOSTATS INSTALLED FOR CONTROL OF PRIMARY HEATING AND COOLING SYSTEMS AND INITIALLY SET BY MANUFACTURER TO CODE SPECIFICATIONS.

4) [403.6.1] ALL MECHANICAL VENTILATION SYSTEM FANS NOT PART OF TESTED AND LISTED HVAC EQUIPMENT MEET EFFICACY AND AIR FLOW LIMITS PER TABLE R403.6.1.

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#### Consultants:

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## 511 CARPENTER ST.

**GREENPORT NY 11944** 


Project No.: IR-02

Seal/ Signature:

MAR 1 1 2021

Scale: AS NOTED Drawing Title:
RCP AND ELECTRICAL PLANS

A-108.00

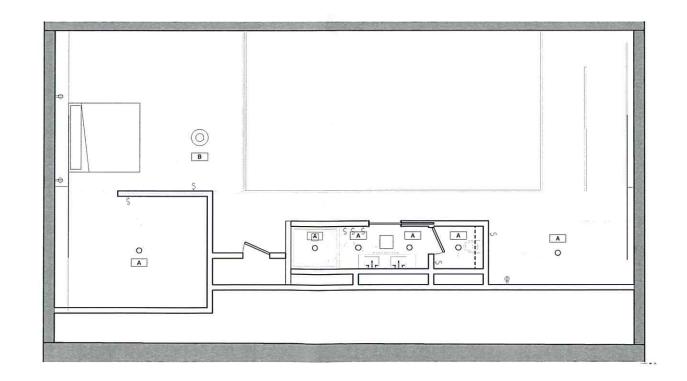

1 3RD F.F. 1/4" = 1'-0"

CARPENTER ST.

1) SECTION 2 1/4" = 1'-0" NOTES

#### DRAWING ISSUE

NO.	DATE	ISSUED FOR
1	12:24:2020	Cremput Village Roview
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#### Consultants:

SPINKLER ENGINEER
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PROTECTION INC.
735 Flanders road
Flanders, New York 11901

Architect of Record:

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Project

## 511 CARPENTER ST.

GREENPORT NY 11944

Project No.: IR-02

Seal/ Signature:

MAR 1 1 2021

Date: Scale:
AS NOTED

Drawing Title:
BUILDING SECTION

Drawing No.


A-300.00

EXISTING P1 WATER SUPPLY RISER
DIAGRAM
1/4" = 1'-0"

NOTES:

[403.4] HVAC piping conveying fluids above 105 °F or chilled fluids below 55 °F are insulated to ≥R-3.
 [403.5.3] Hot water pipes are insulated to ≥R-3.

EXG VENT STACK TO REMAIN

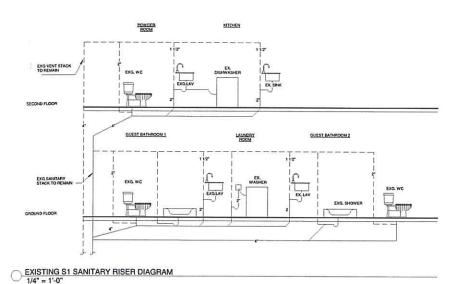

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DRAWING ISSUE

ISSUED FOR Greenport Village Review Greenport ZBA Submittal

NOTES

SPINKLER ENGINEER SENTRY AUTOMATIC FIRE PROTECTION INC. 735 Flanders road Flanders, New York 11901

Architect of Record:

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511 CARPENTER ST. **GREENPORT NY 11944** 

Project No.: IR-02

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MAR 1 1 2021

Drawing Title:
PLUMBING RISER DIAGRAM

P-100.00

